WODHENGE

COMMUNITY FORGE PORCH ADDITION

DESIGN BUILD STUDIO

CARNEGIE MELLON UNIVERSITY SCHOOL OF ARCHITECTURE 5000 FORBES AVENUE PITTSBURGH, PA 15213

K Y L E B A N C R O F T TAKUMI JORDAN DAVIS T A Y L O R L A T I M E R D E C E M B E R 1 0 , 2 0 1 9 F O R R E V I E W

SHEET LIST: G.00 TITLE PAGE L.01 SITE PLAN A1.01 GROUND FLOOR PLAN A1.02 DECK PLAN A1.03 ROOF PLAN A2.01 NORTH ELEVATION A2.02 WEST ELEVATION A3.01 SECTION 1 A3.02 SECTION 2 A3.03 SECTION 3 A4.01 DETAILS A4.02 DETAILS A4.03 DETAILS A4.04 DETAILS S1.01 DECK FRAMING PLAN S1.02 ROOF FRAMING PLAN PR.01 PROTOTYPE TITLE PAGE PR.02 PROTOTYPE PERSPECTIVE PR.03 PROTOTYPE PLAN EN SITU PR.04 PROTOTYPE ELEVATIONS EN SITU PR.05 PROTOTYPE CUT SHEET PR.06 PROTOTYPE ASSEMBLY SEQUENCE

ABBREVIATIONS: ABV. = ABOVE

' = FEET

B.O. = BOTTOM OF CL. = CENTER LINE CLR. = CLEARANCE COL. = COLUMN CONC. = CONCRETE DN. = DOWN EL. = ELEVATION EPMD = ETHYLENE PROPYLENE DIENE MONOMER EXT. = EXTERIOR FDTN. = FOUNDATION GA. = GAUGE GALV. = GALVANIZED INT. = INTERIOR LF. = LINEAR FEET LVL. = LAMINATED VENEER LUMBER MAX. = MAXIMUM MIN. = MIN. = MINIMUM NTS. = NOT TO SCALE O.C. = ON CENTER OPP. = OPPOSITE R.O. = ROUGH OPENING S.F. = SQUARE FEET T.O. = TOP OF TYP. = TYPICAL W/ = WITH " = INCHES

= NUMBER SYMBOLS: - ASSEMBLY DESIGNATION WALL TYPE TAG (15) NOTE DESIGNATION **KEYNOTE TAG** - SHEET DETAIL **ELEVATION TAG** - SHEET DETAIL **BUILDING SECTION TAG** 1|A5.00 SHEET L DETAIL

RESTROOM ROOM NAME
101 203 SF SQUARE FOOTAGE ROOM NUMBER ROOM DESIGNATION TAG A(33) — DESIGNATOR WINDOW TYPE TAG 333E) — DESIGNATOR DOOR TYPE TAG 1 DETAIL A2.02 SHEET DETAIL REFERENCE TAG

_____ DESIGNATOR SPOT ELEVATION TAG SLOPE DIRECTION DESIGNATOR

WALL SECTION TAG

SLOPE TAG € — DESIGNATOR


BEAM SC.2 CENTERLINE TAG

ENTRANCE — MAIN ENTRANCE ENTRANCE SECONDARY ENTRANCE COVERED SECONDARY ENTRANCE

CONTACT: DESIGN BUILD STUDIO CARNEGIE MELLON UNIVERSITY SCHOOL OF ARCHITECTURE

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DRAWN BY: TAKUMI DAVIS JORDAND@ANDREW.CMU.EDU TAYLOR LATIMER TIL@ANDREW.CMU.EDU KYLE BANCROFT KYLEBANC@ANDREW.CMU.EDU

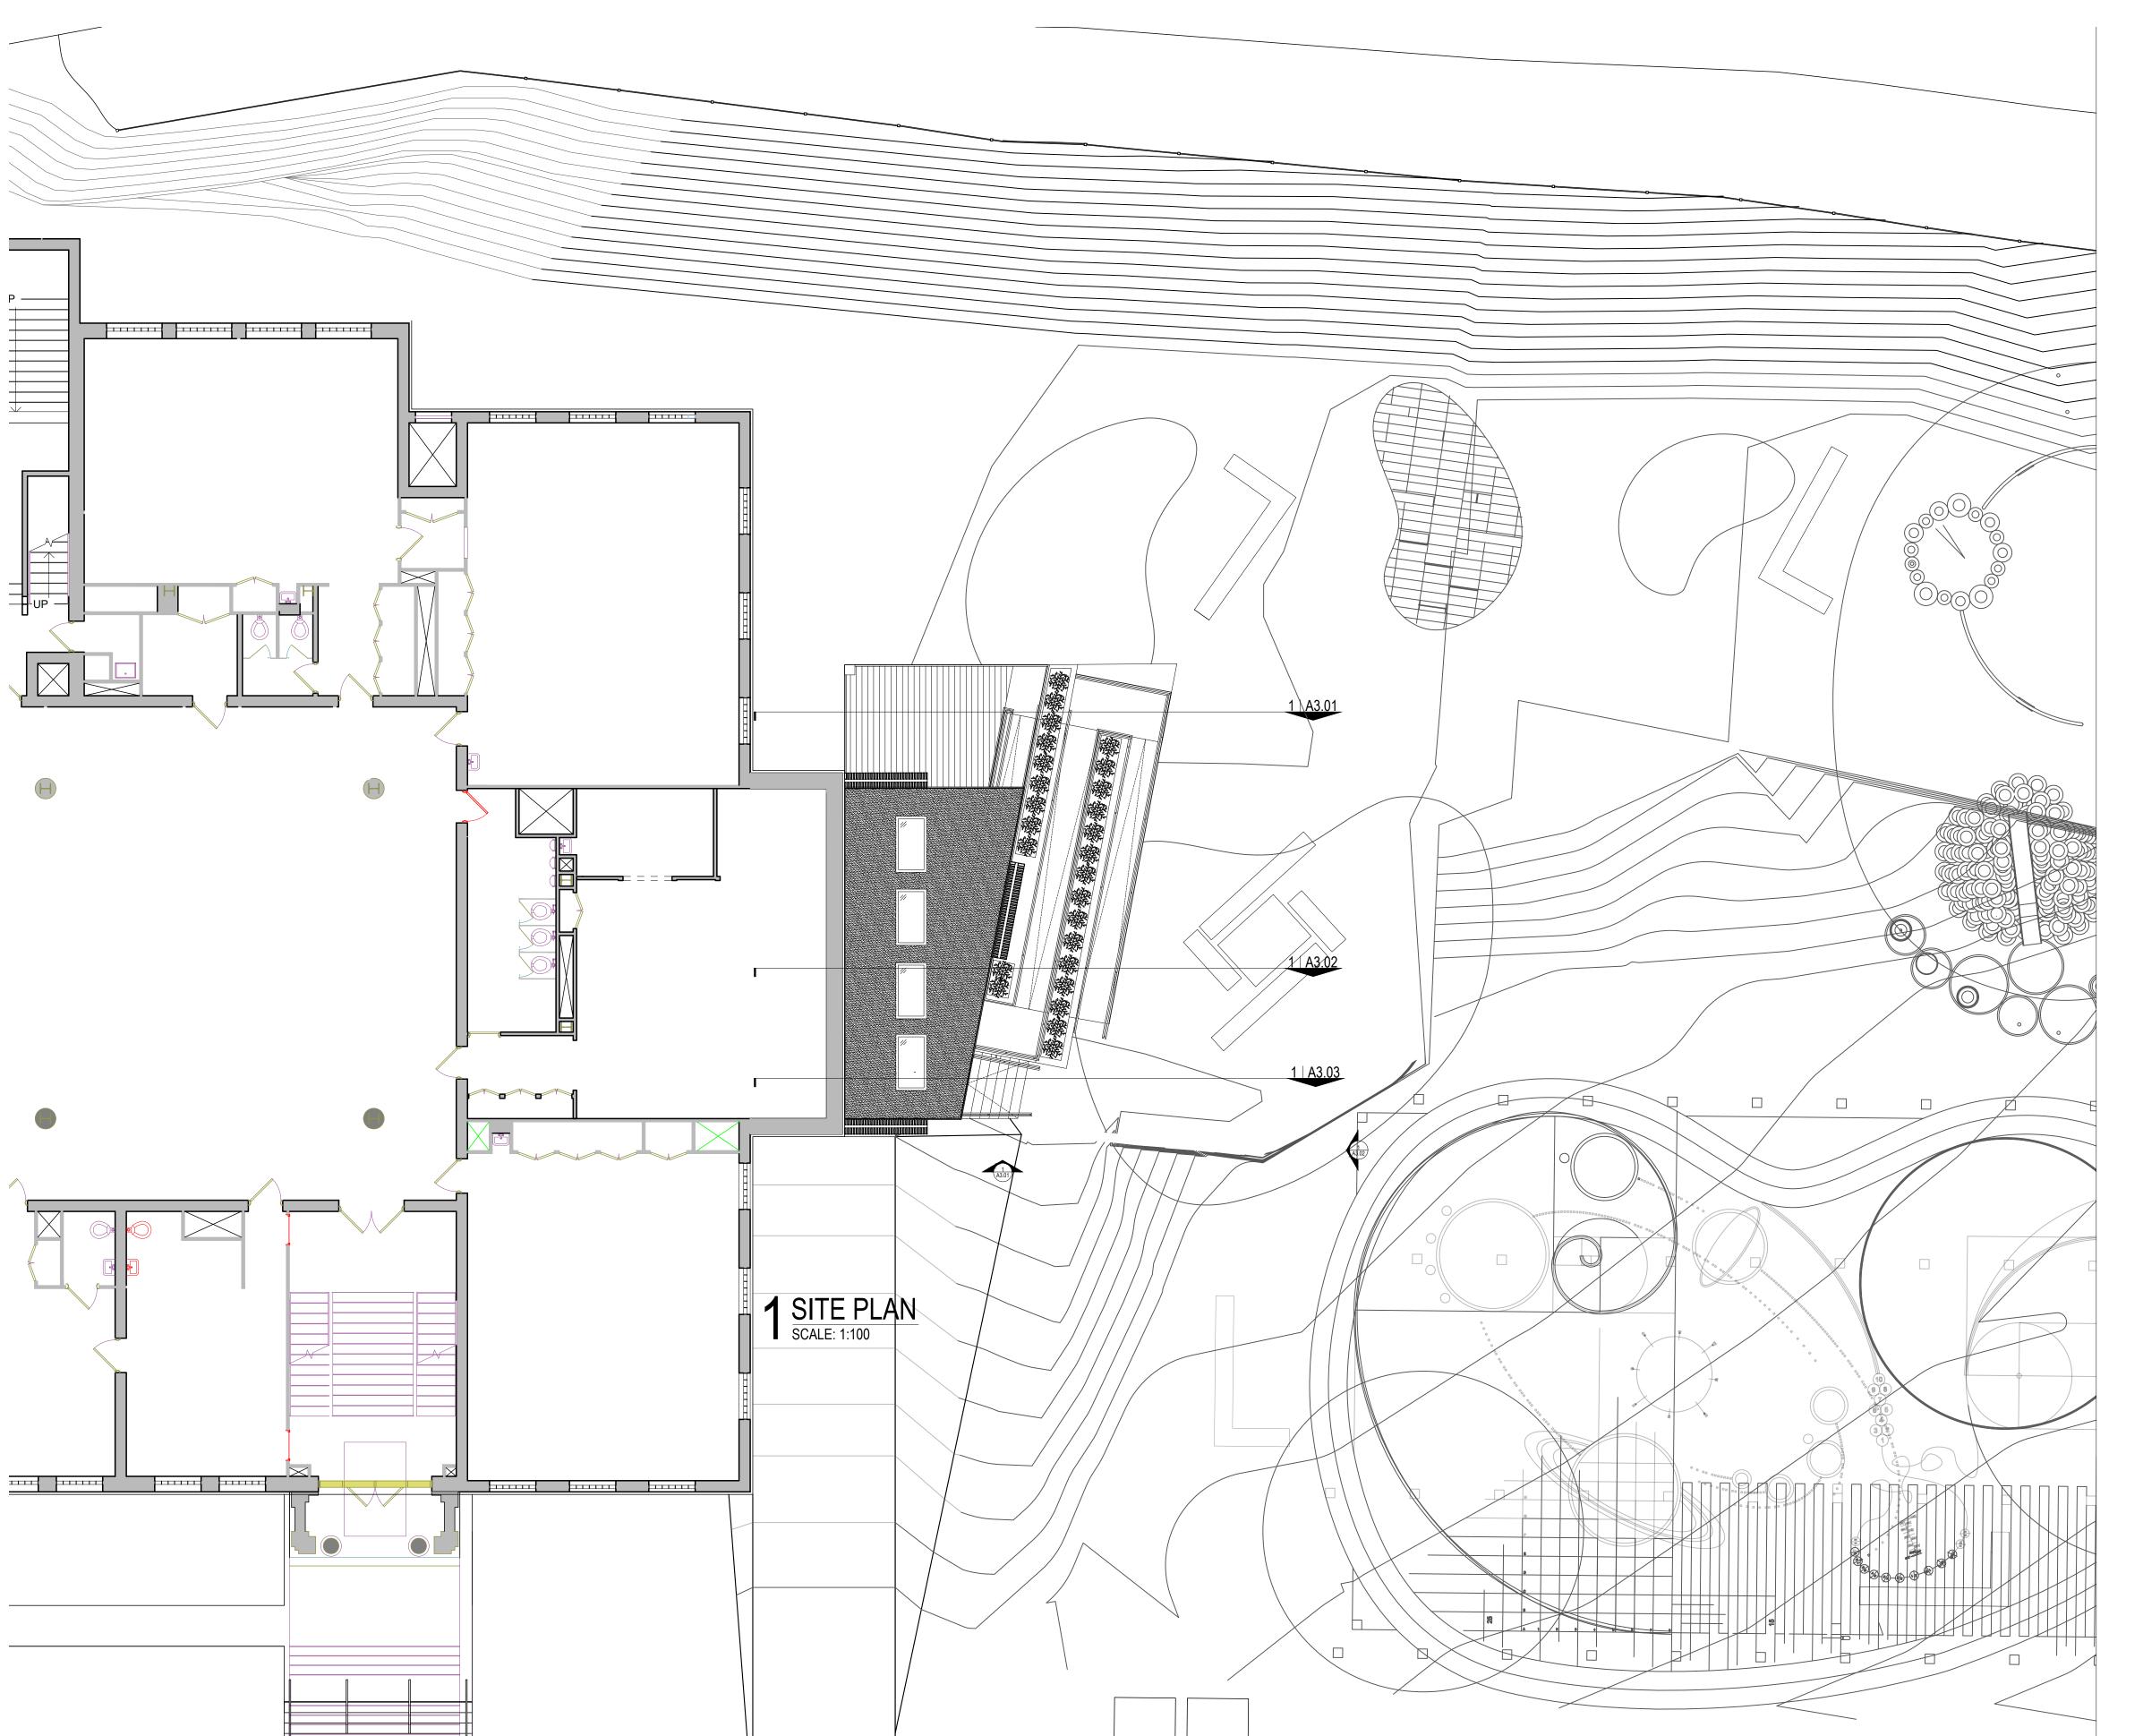

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CONC. PAVING

CLEAN CRUSHED STONE GRAVEL BACKFILL

INFILL SOIL

CUT OR FILL SOIL

SAND OR GRANULAR PAD

CUT WOOD GRAIN

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7 152 DRAWN BY: KYLE BANCROFT

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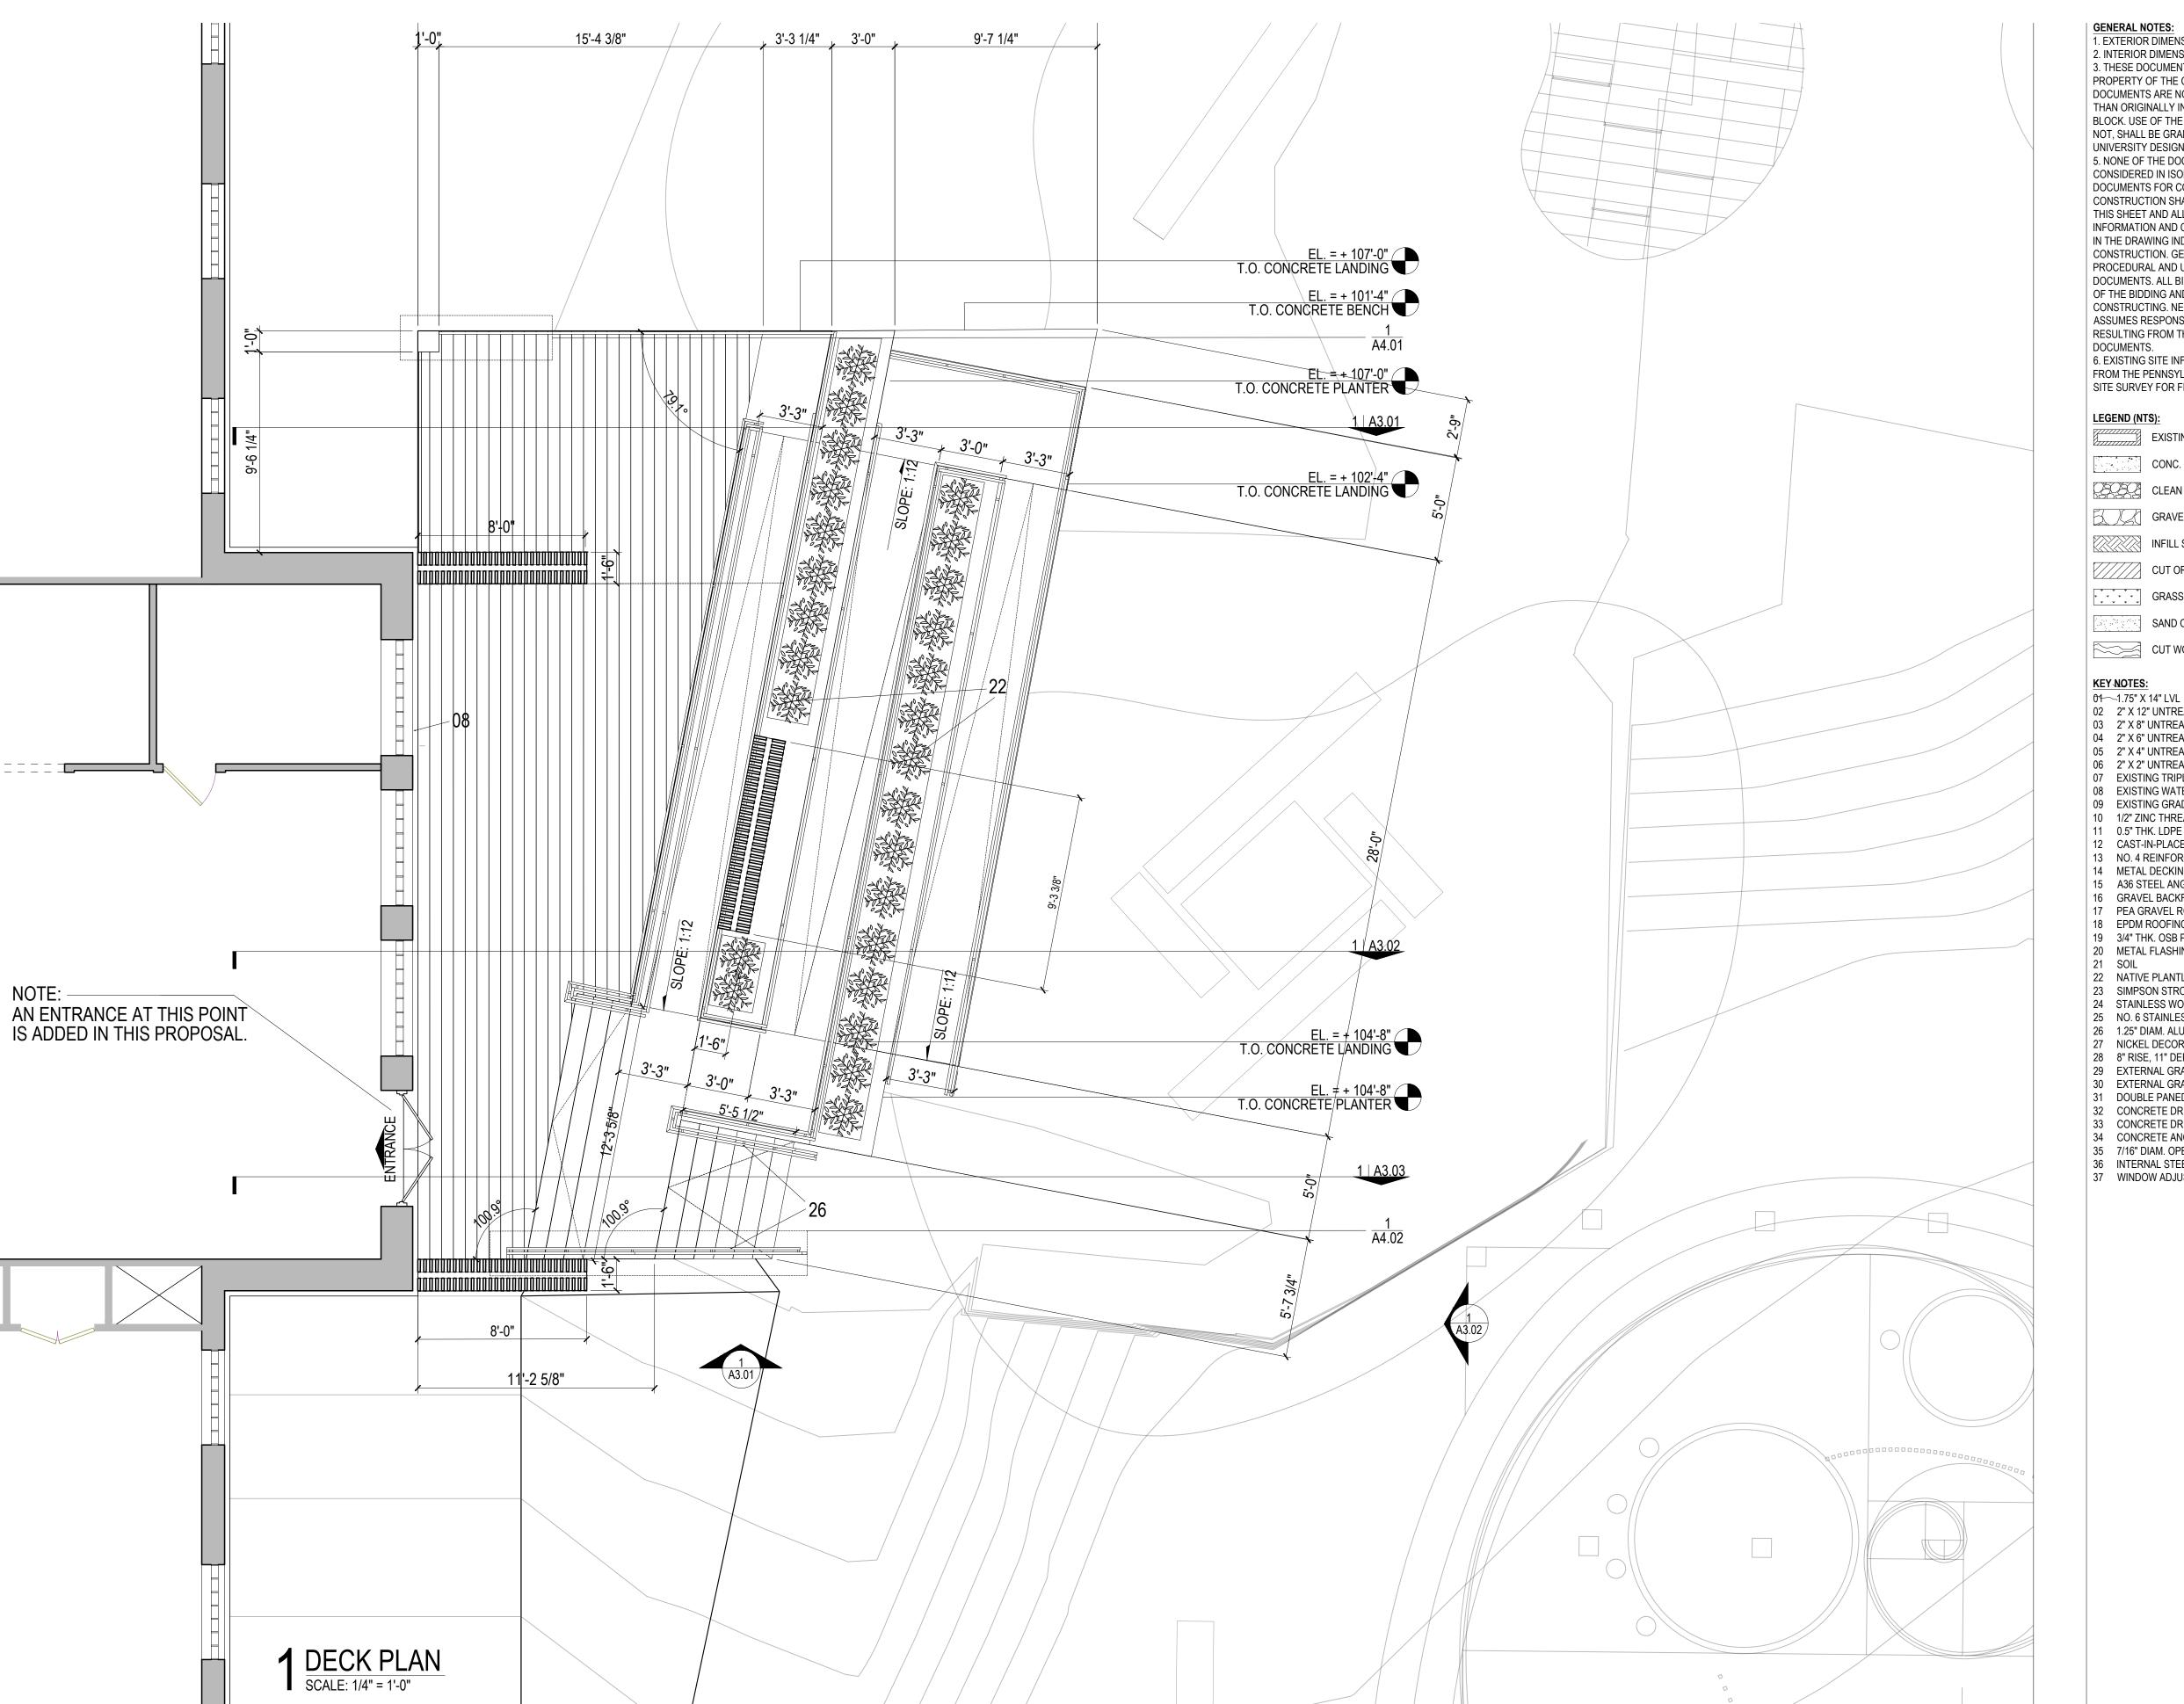
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7 152 DRAWN BY: KYLE BANCROFT TAKUMI DAVIS

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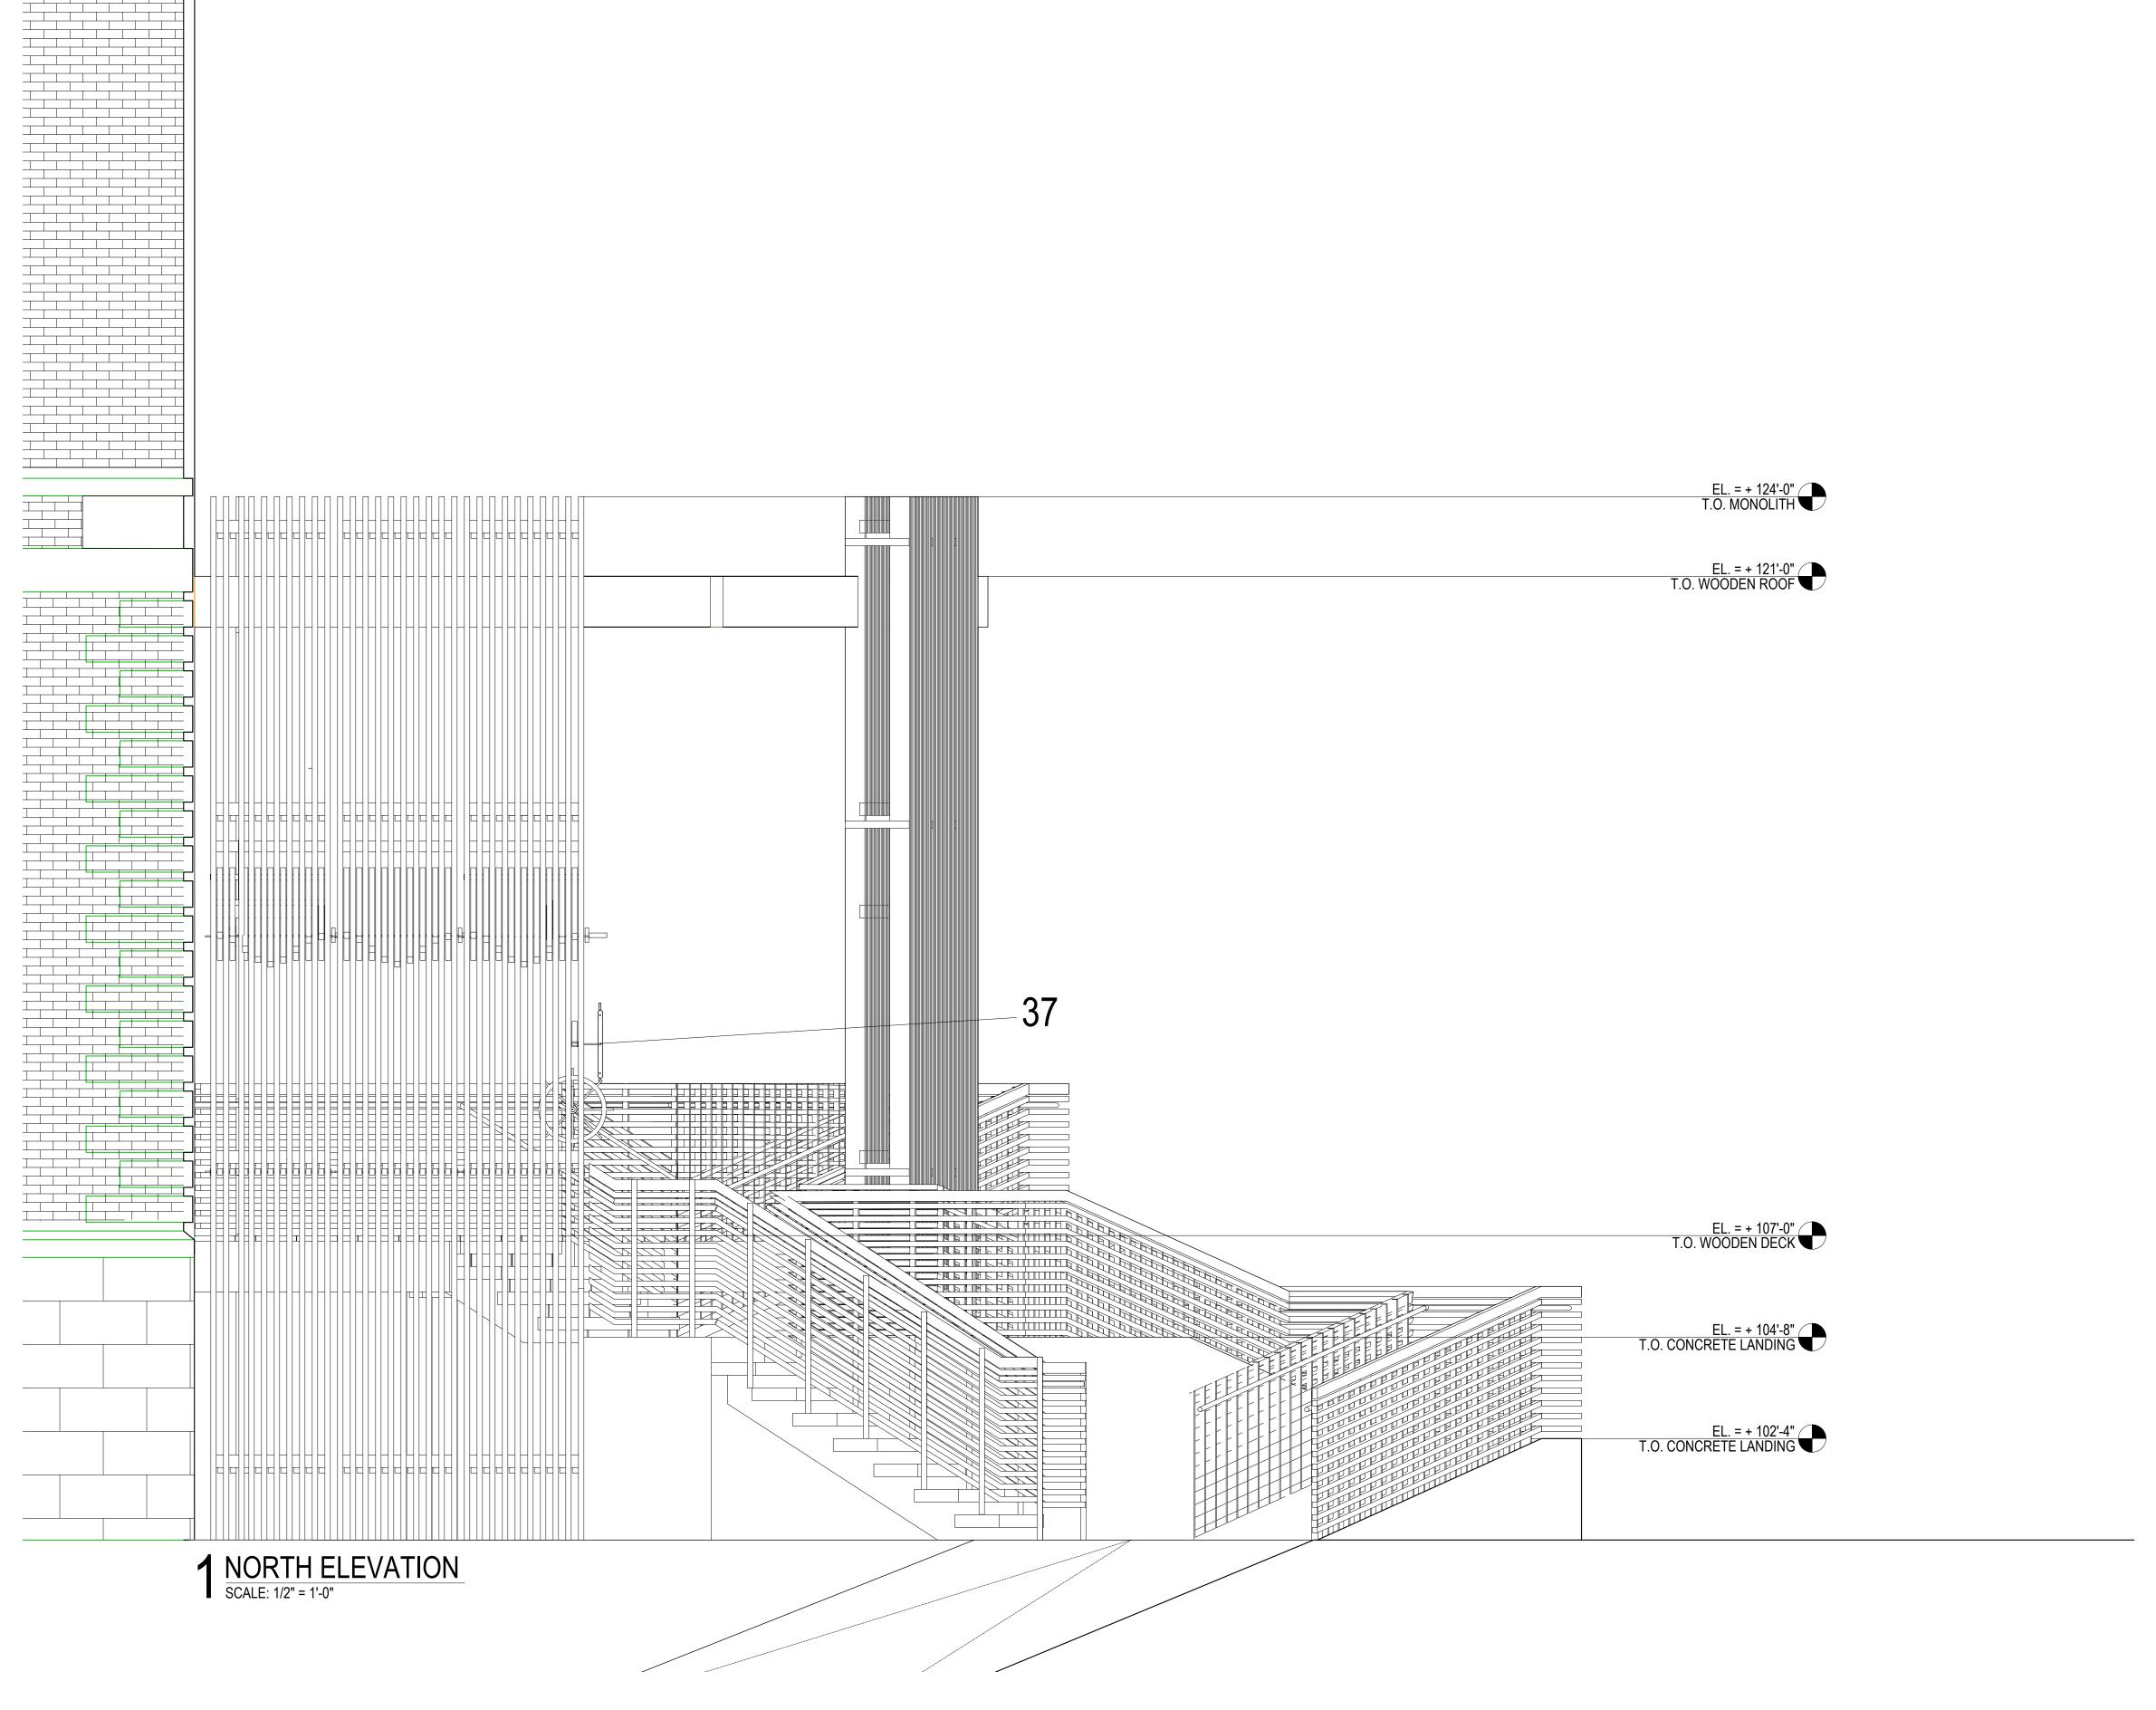
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15 ОШ COMMUNITY 1256 FRANKLIN / WILKINSBURG, DRAWN BY:

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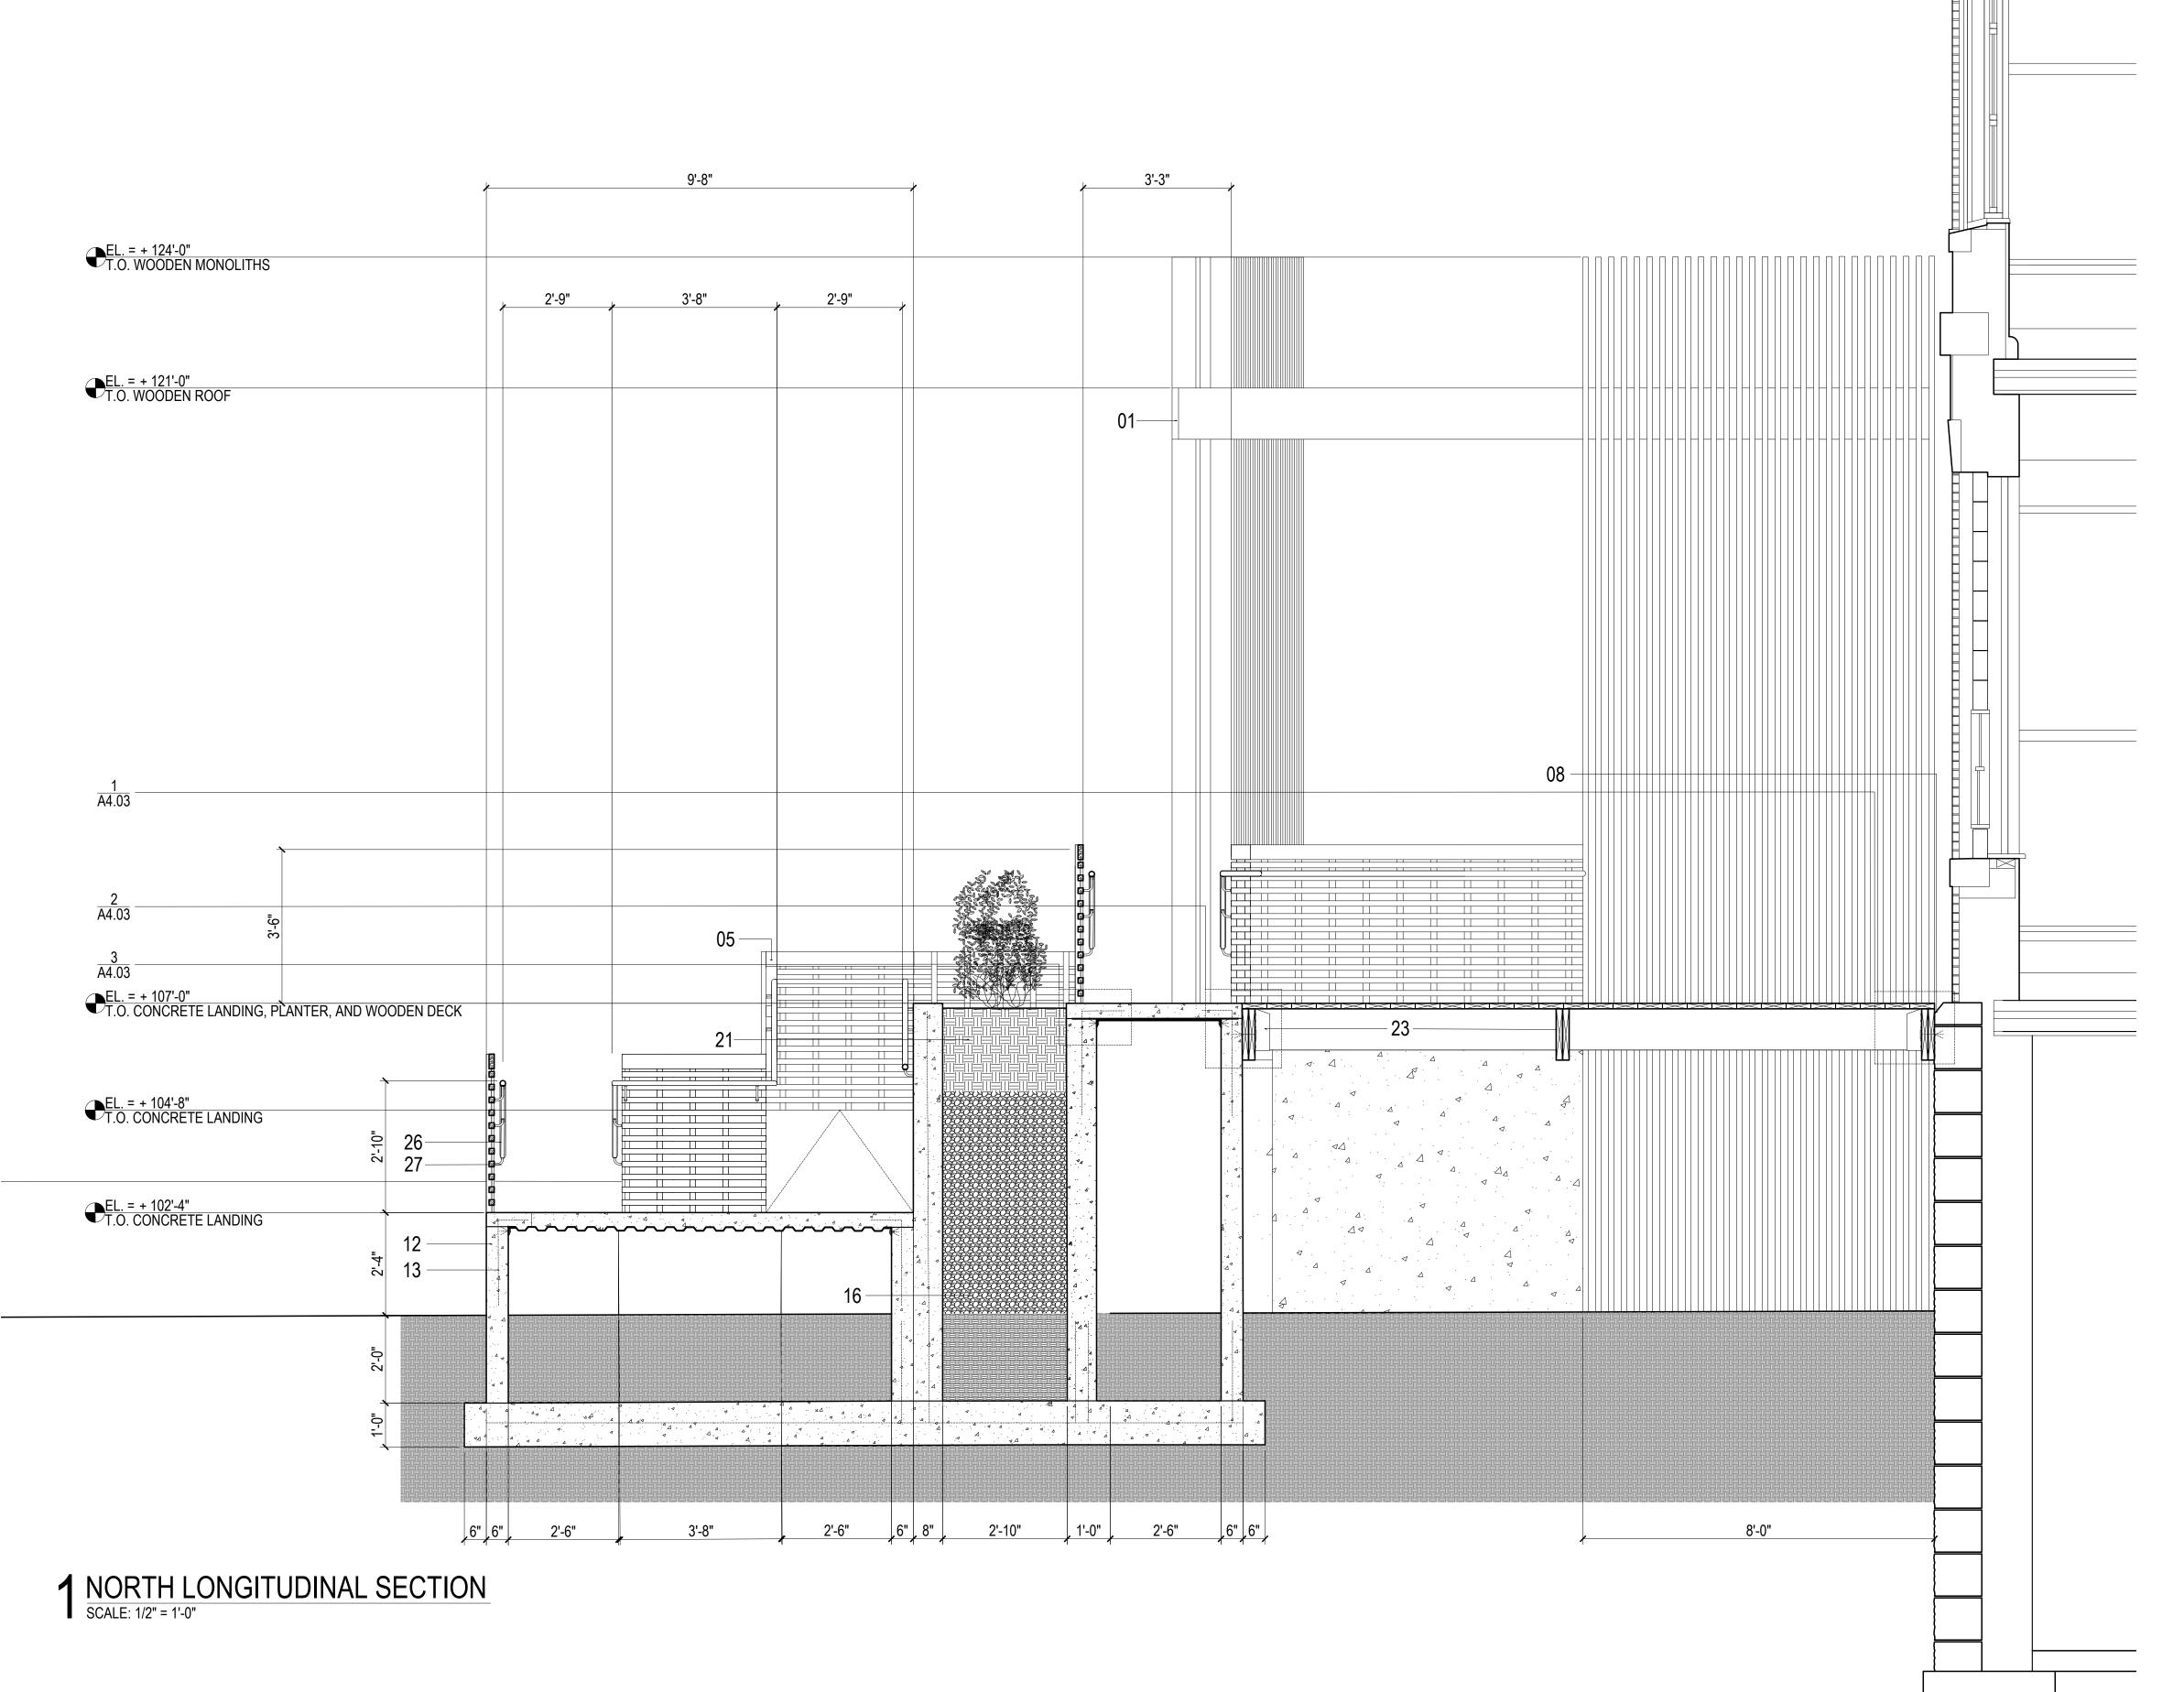
KYLE BANCROFT TAKUMI DAVIS

TAYLOR LATIMER

DECEMBER 2 0 1 9

F O R R E V I E W

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LEGEND (NTS):

EXISTING BUILDING CONC. PAVING CLEAN CRUSHED STONE GRAVEL BACKFILL INFILL SOIL

CUT OR FILL SOIL

CUT WOOD GRAIN

SAND OR GRANULAR PAD

01 1.75" X 14" LVL 02 2" X 12" UNTREATED DIM. LUMBER

03 2" X 8" UNTREATED DIM. LUMBER 04 2" X 6" UNTREATED DIM. LUMBER

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08 EXISTING WATER TABLE

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11 0.5" THK. LDPE SPACER

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19 3/4" THK. OSB PLYWOOD 20 METAL FLASHING21 SOIL

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DRAWN BY:

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D O S G D

DECEMBER 2 0 1 9 F O R R E V I E W

A3.01

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1 NORTH LONGITUDINAL SECTION SCALE: 1/2" = 1'-0"

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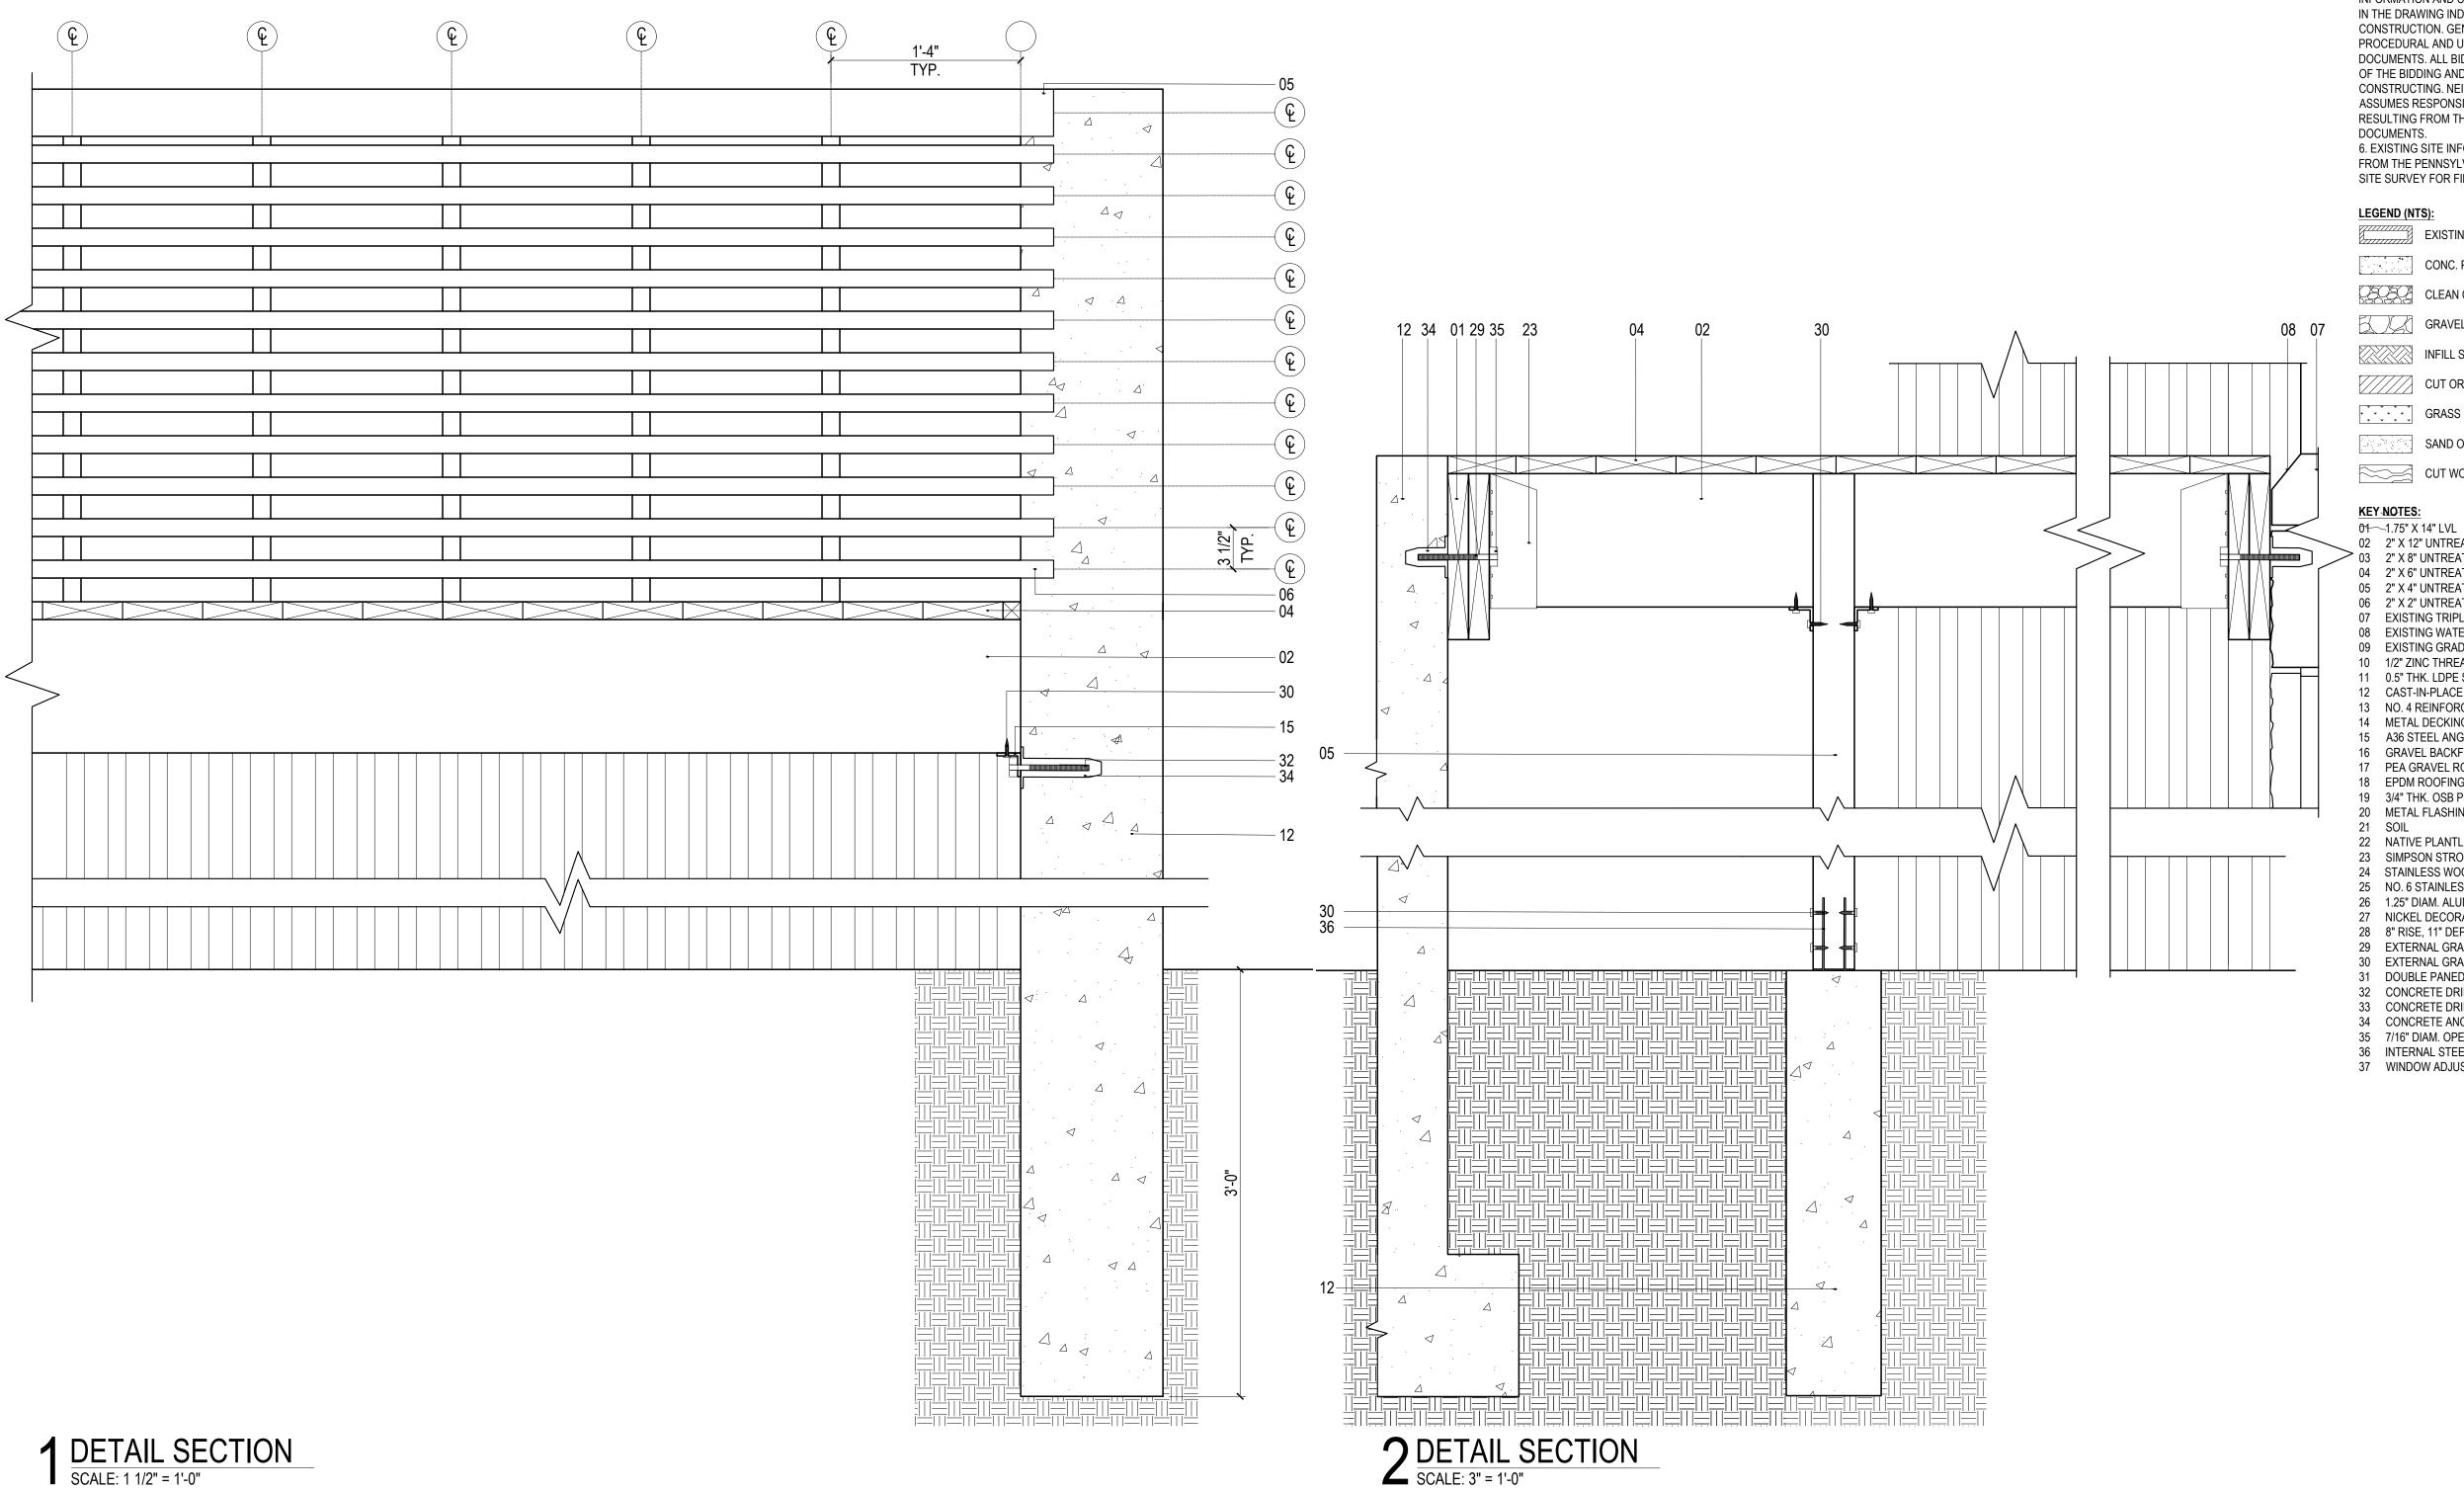
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KYLE BANCROFT TAKUMI DAVIS TAYLOR LATIMER

DECEMBER 2 0 1 9 F O R R E V I E W

A3.03



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DRAWN BY: KYLE BANCROFT TAKUMI DAVIS TAYLOR LATIMER

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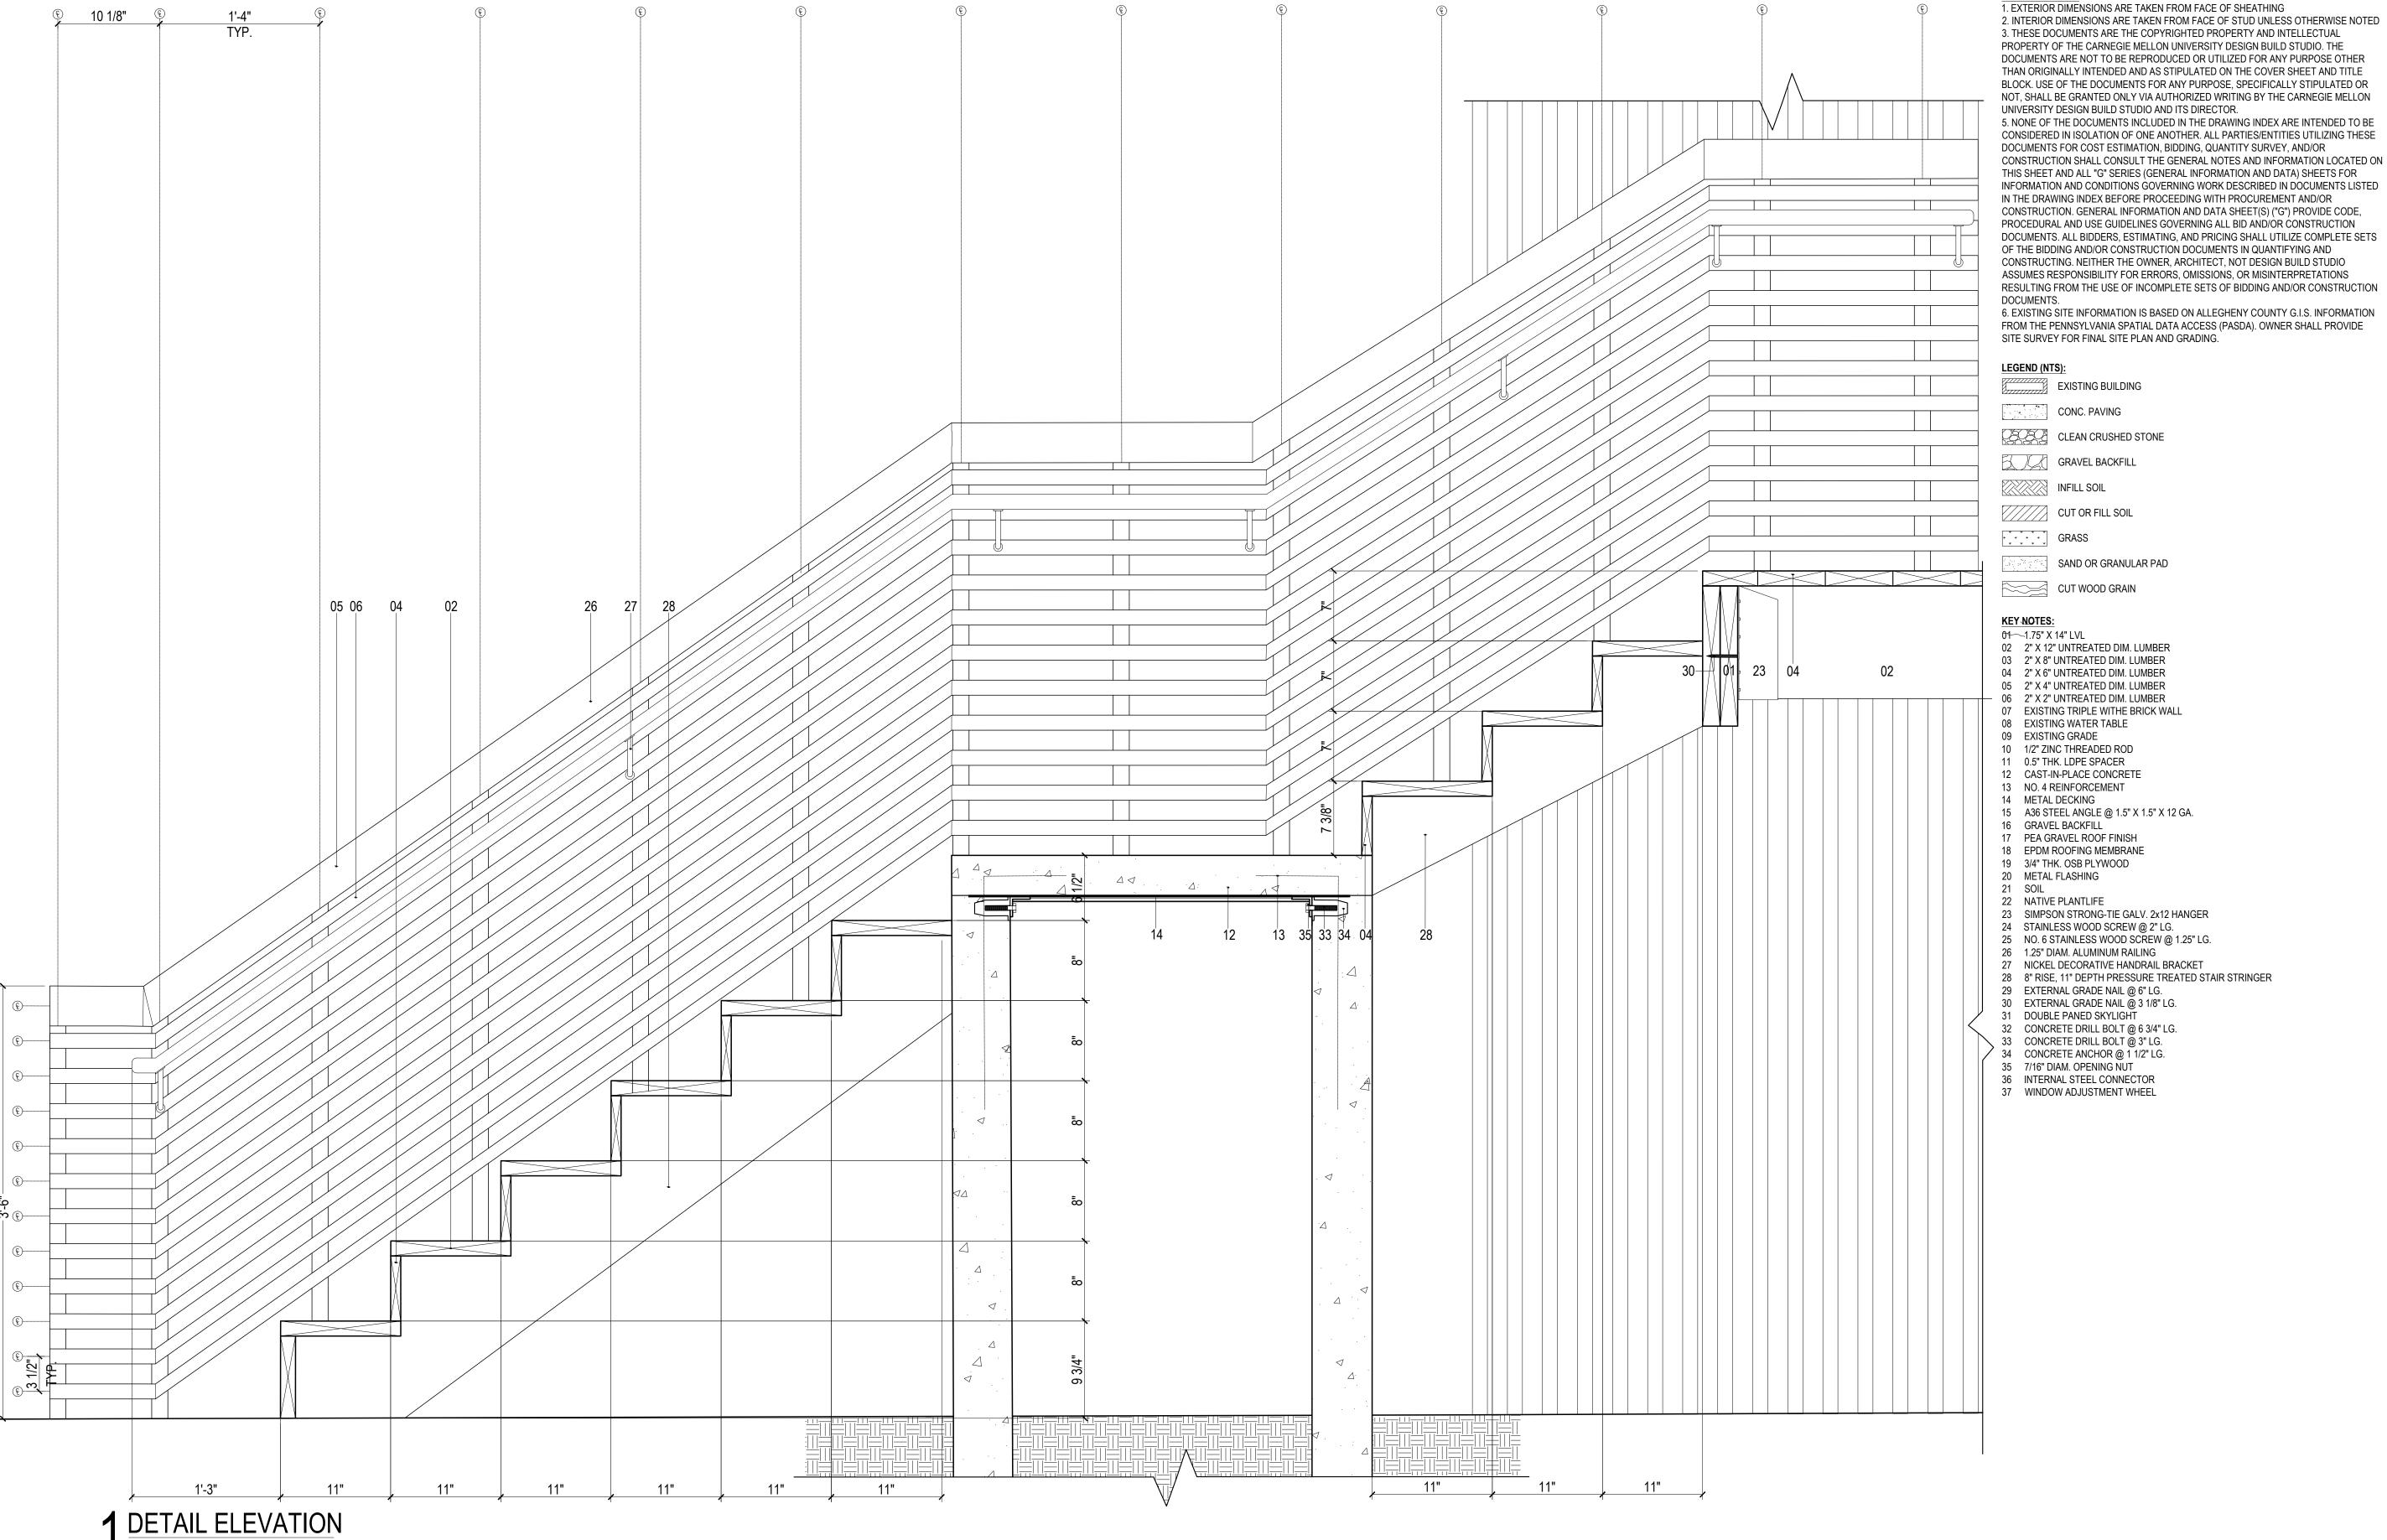
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SCALE: 1 1/2" = 1'-0"

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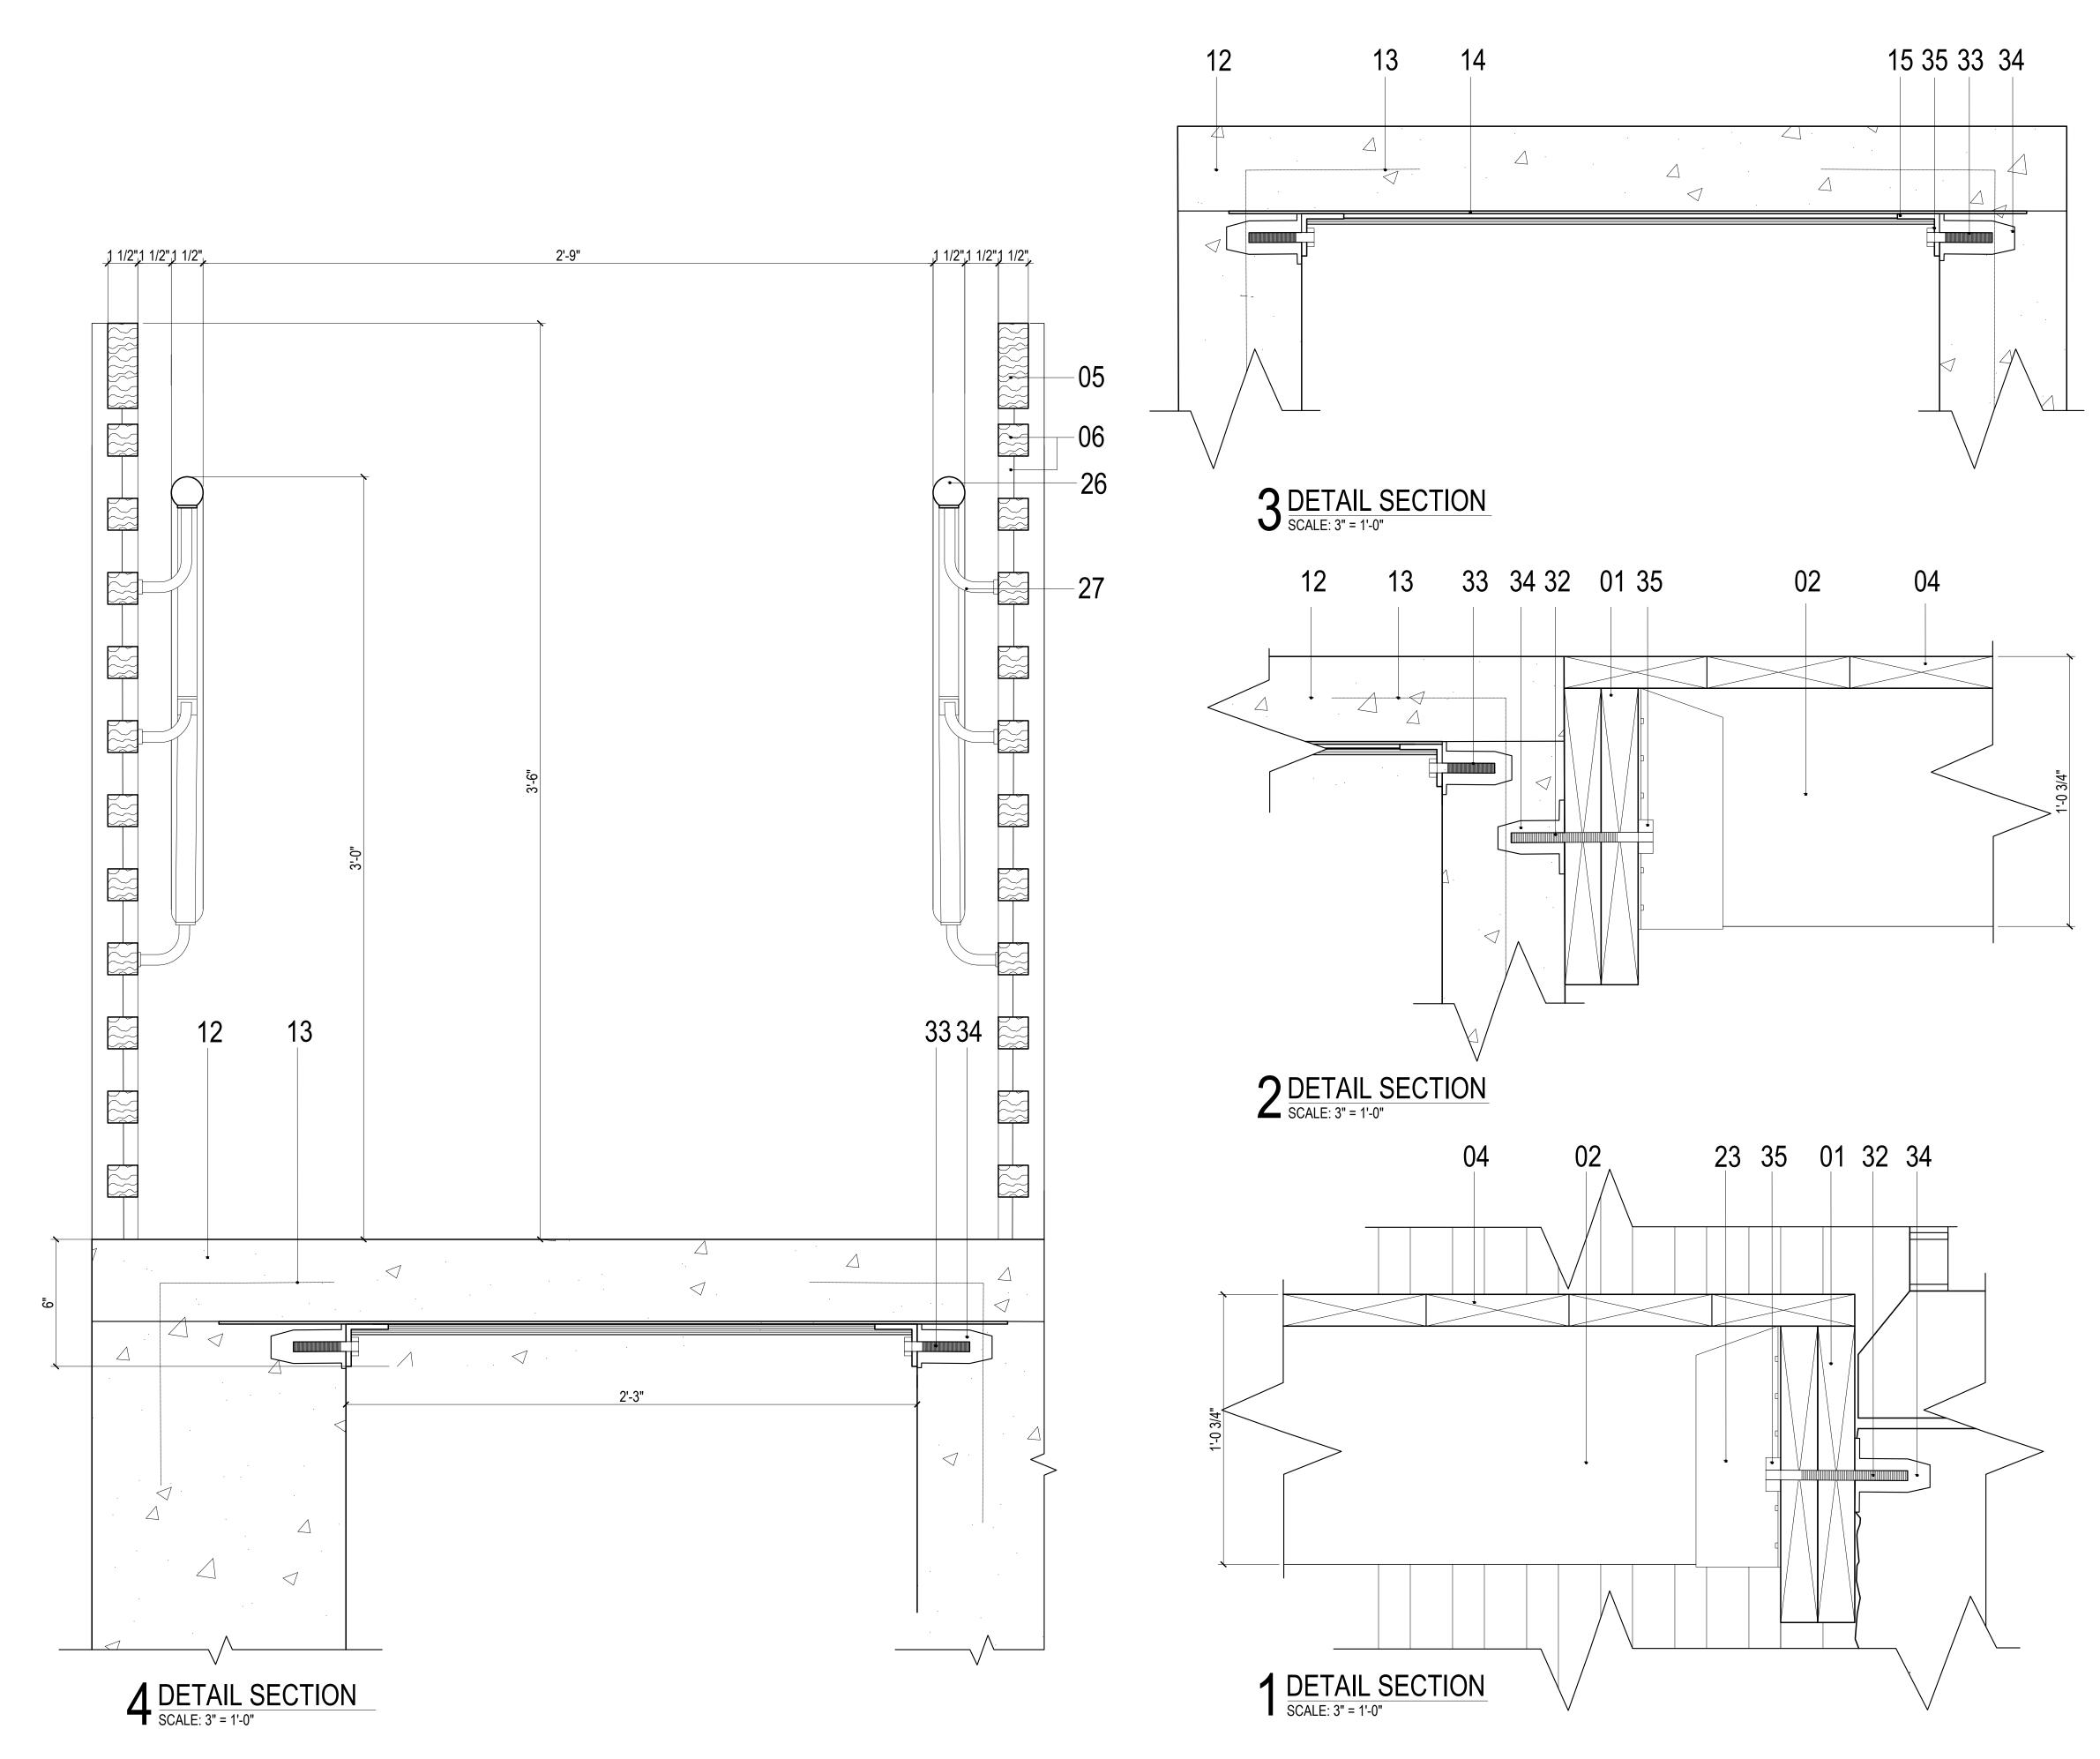
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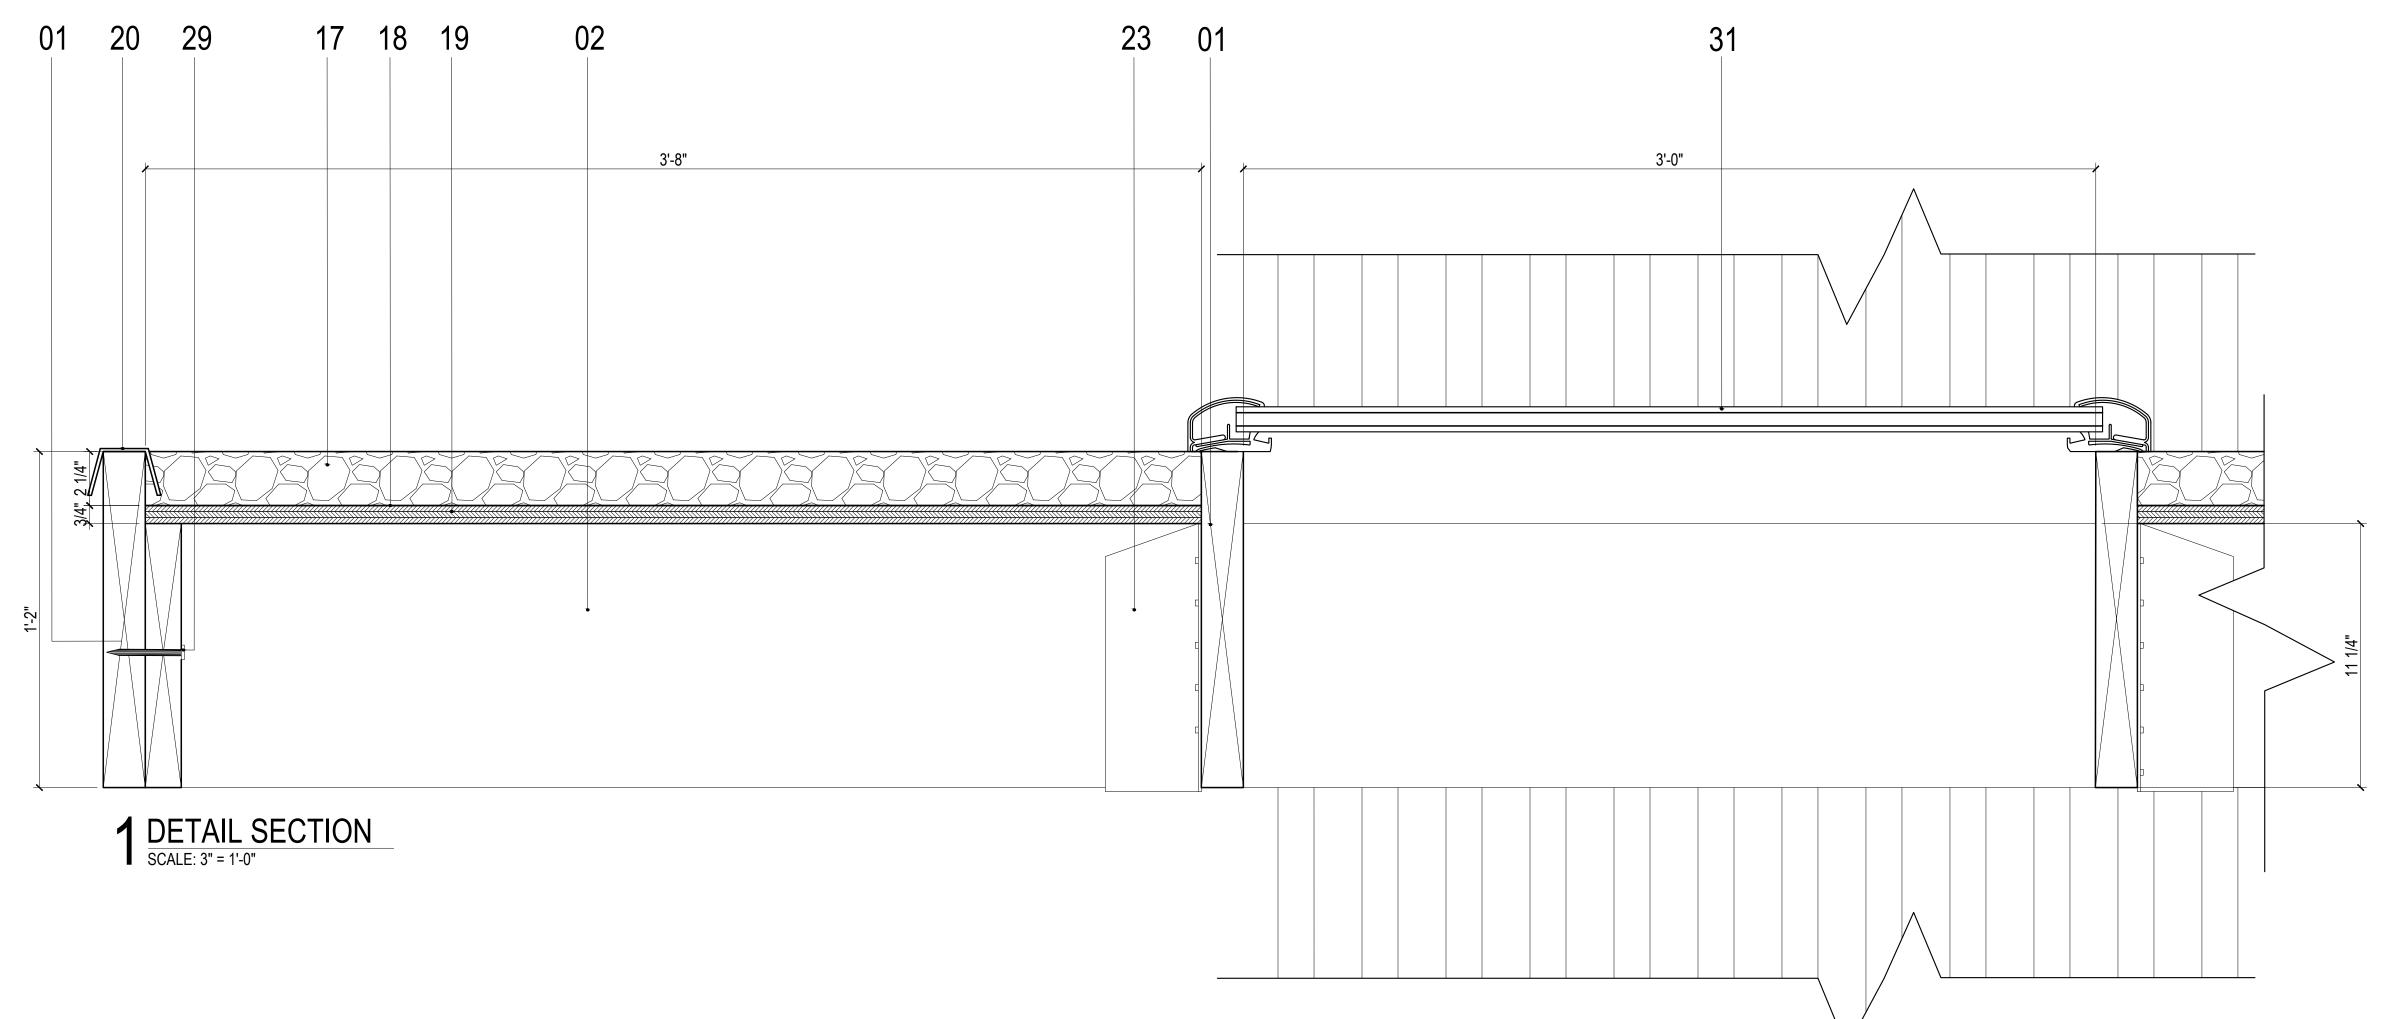
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31 DOUBLE PANED SKYLIGHT

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34 CONCRETE ANCHOR @ 1 1/2" LG.

35 7/16" DIAM. OPENING NUT

36 INTERNAL STEEL CONNECTOR 37 WINDOW ADJUSTMENT WHEEL DRAWN BY: KYLE BANCROFT TAKUMI DAVIS TAYLOR LATIMER

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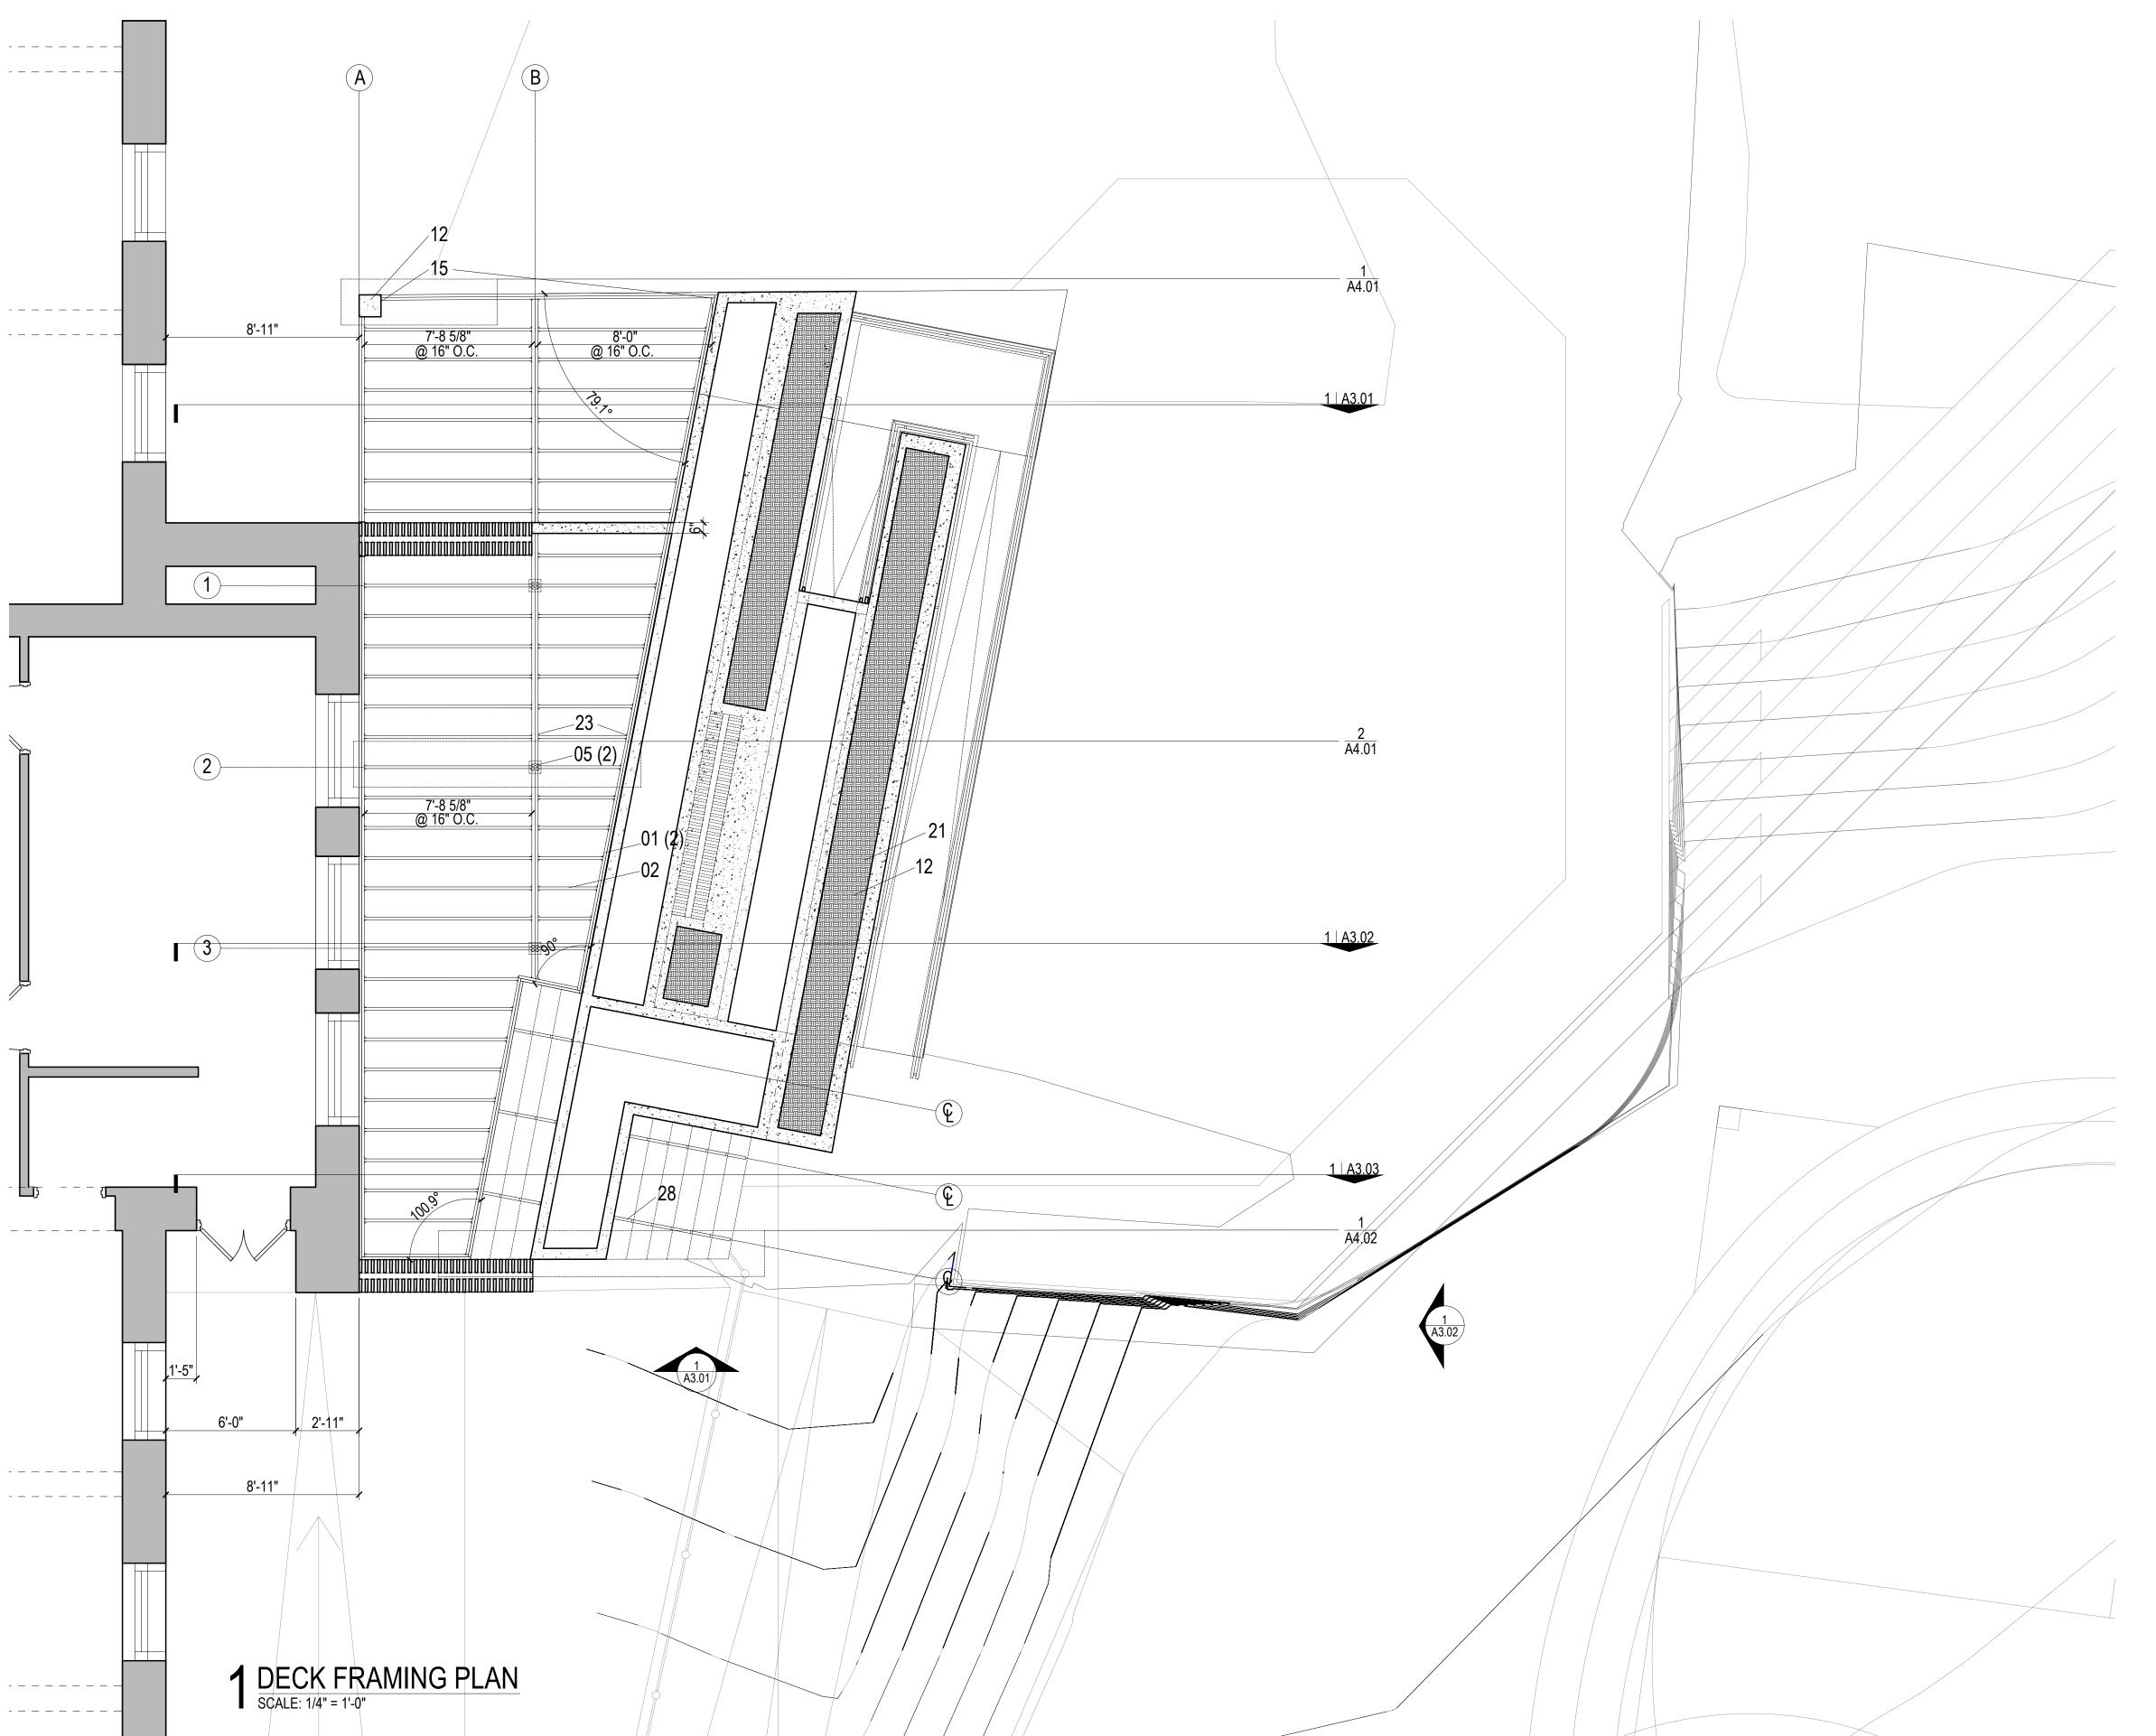
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LEGEND (NTS):



GRAVEL BACKFILL INFILL SOIL

CUT OR FILL SOIL GRASS

SAND OR GRANULAR PAD

CUT WOOD GRAIN

KEY NOTES:

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DRAWN BY: KYLE BANCROFT TAKUMI DAVIS TAYLOR LATIMER

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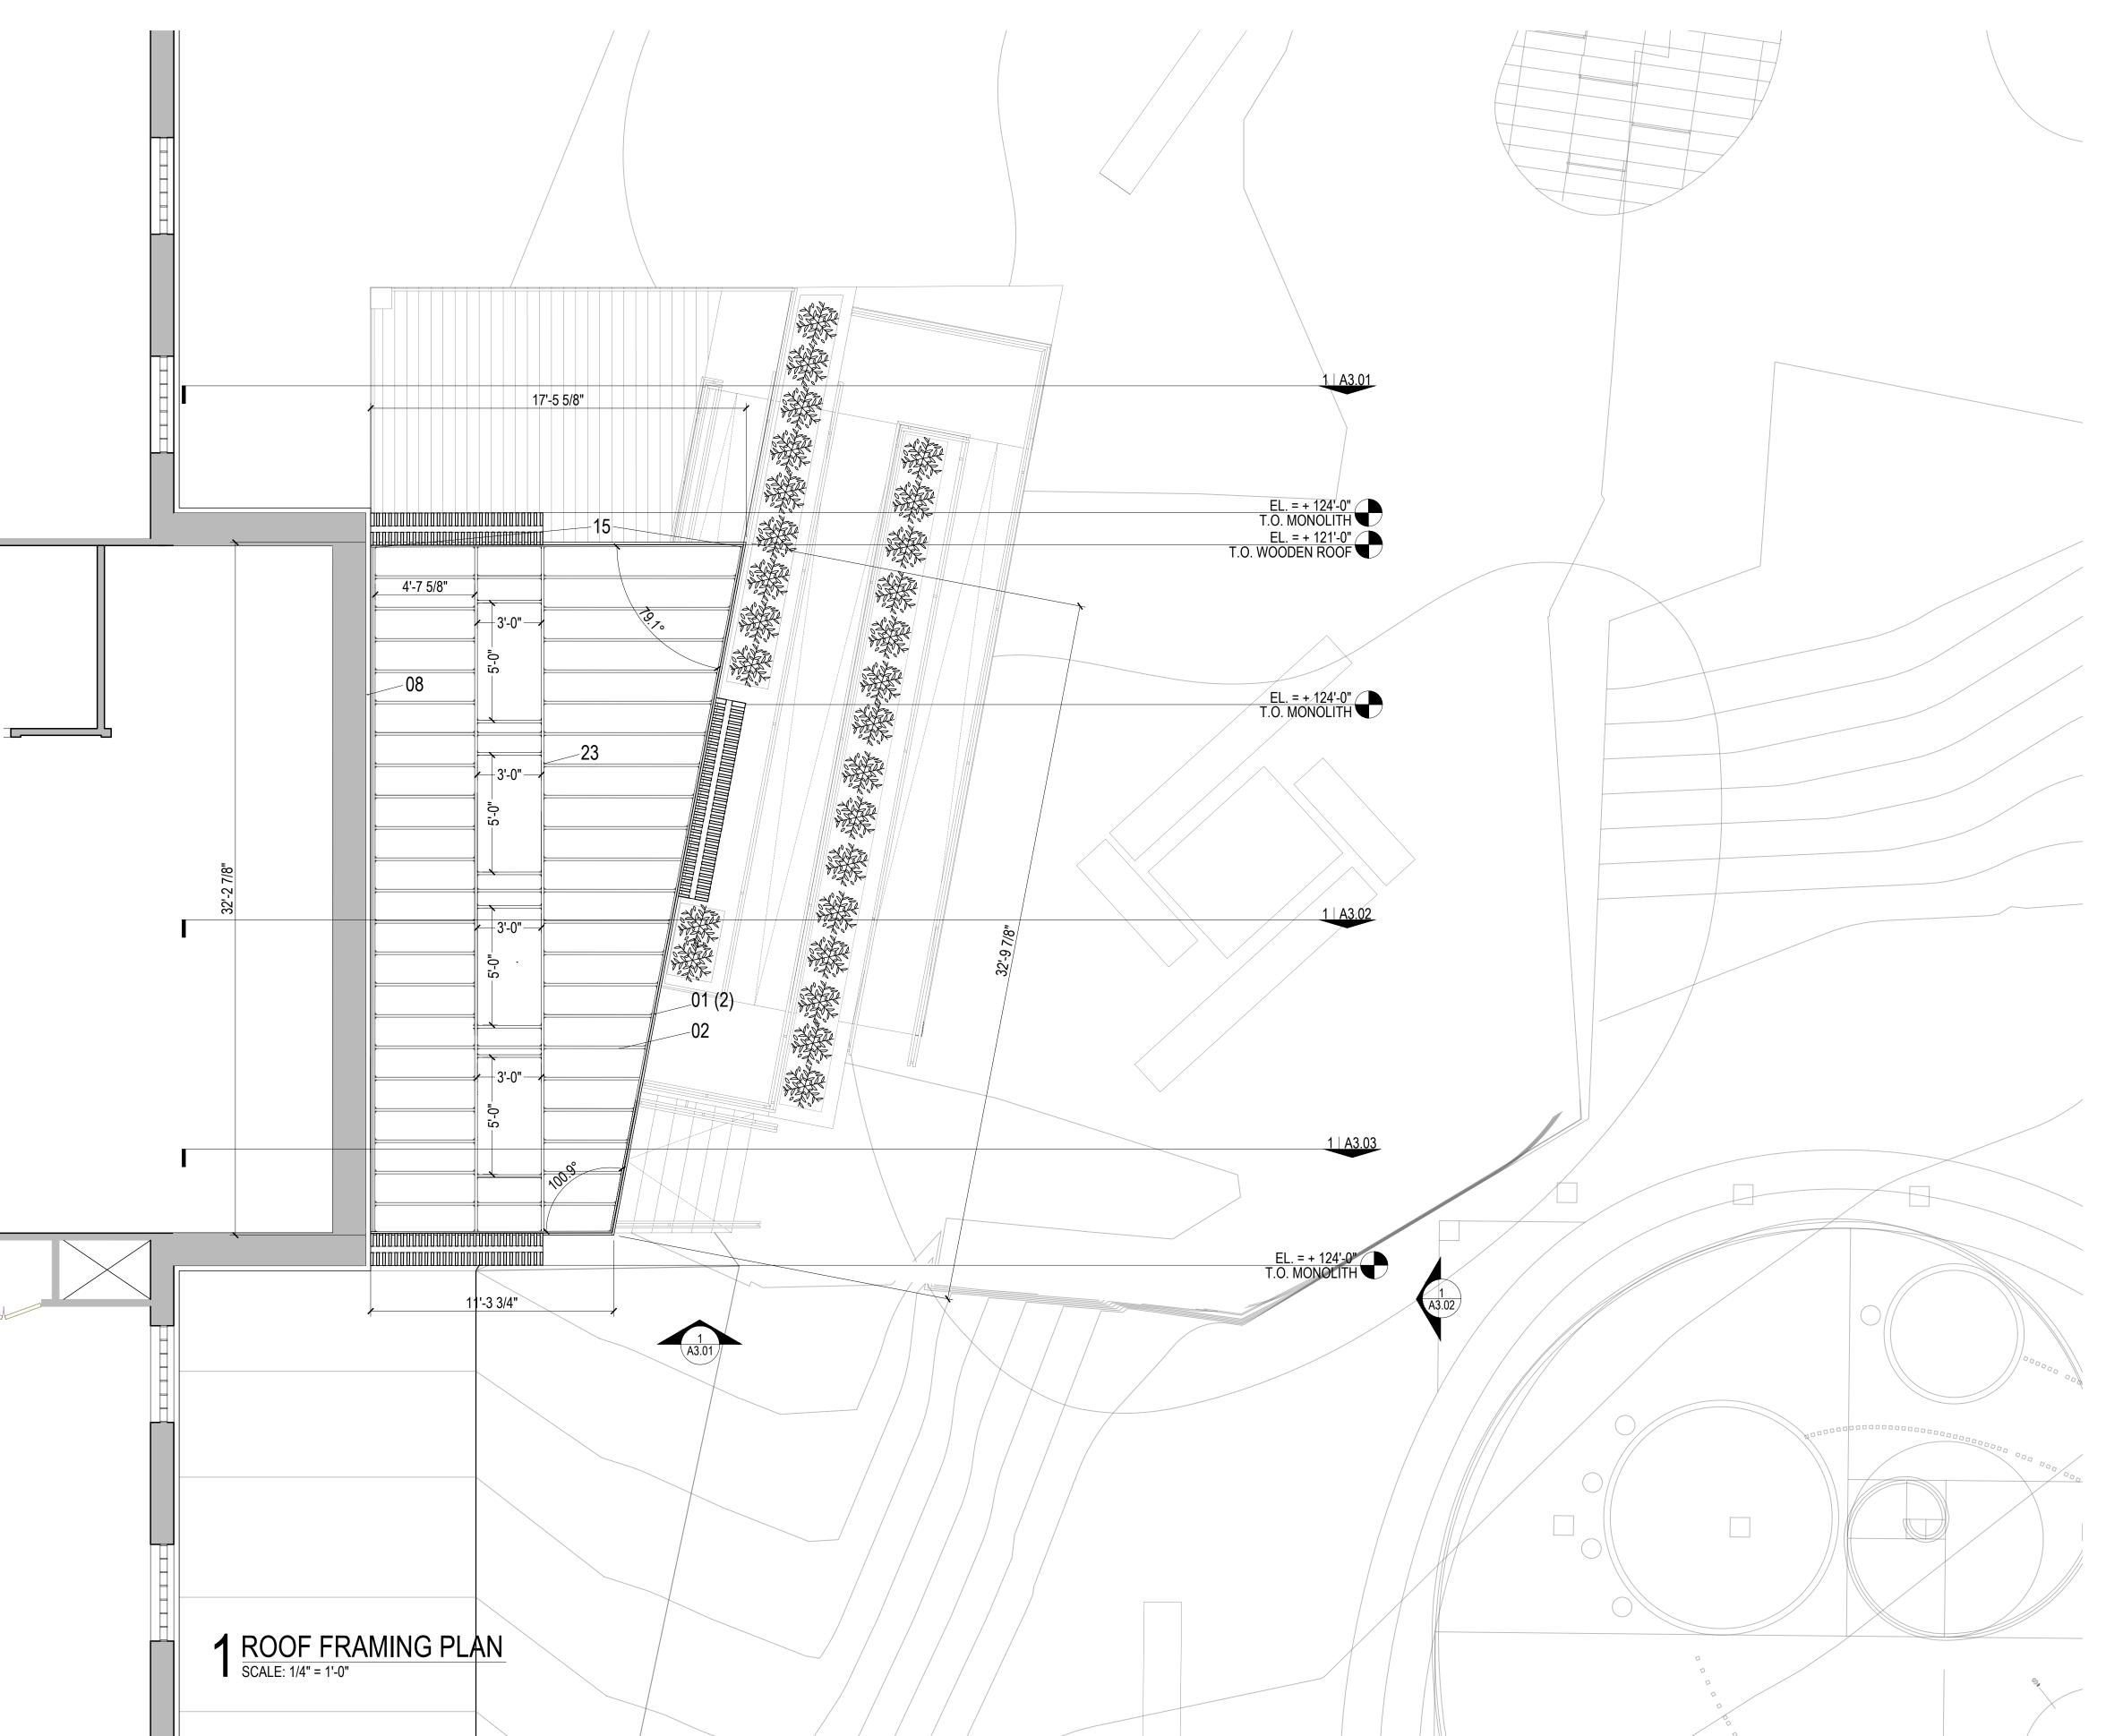
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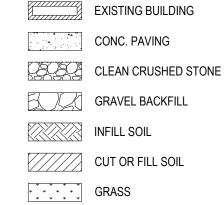
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CUT WOOD GRAIN

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DRAWN BY: KYLE BANCROFT TAKUMI DAVIS TAYLOR LATIMER

DECEMBER 2 0 1 9 F O R R E V I E W

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MONOLITH PROTOTYPE

PROJECT REET
214 NORTH LEXINGTON STREET
PITTSBURGH PA 15208

DESIGN BUILD STUDIO CARNEGIE MELLON UNIVERSITY

CARNEGIE MELLON UNIVERSITY SCHOOL OF ARCHITECTURE 5000 FORBES AVENUE PITTSBURGH, PA 15213

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SHEET LIST: G.00 TITLE PAGE L.01 SITE PLAN A1.01 GROUND FLOOR PLAN A1.02 DECK PLAN A1.03 ROOF PLAN A2.01 NORTH ELEVATION A2.02 WEST ELEVATION A3.01 SECTION 1 A3.02 SECTION 2 A3.03 SECTION 3 A4.01 DETAILS A4.02 DETAILS A4.03 DETAILS A4.04 DETAILS S1.01 DECK FRAMING PLAN S1.02 ROOF FRAMING PLAN PR.01 PROTOTYPE TITLE PAGE PR.02 PROTOTYPE PERSPECTIVE PR.03 PROTOTYPE PLAN EN SITU PR.04 PROTOTYPE ELEVATIONS EN SITU PR.05 PROTOTYPE CUT SHEET PR.06 PROTOTYPE ASSEMBLY SEQUENCE

ABBREVIATIONS:

B.O. = BOTTOM OF CL. = CENTER LINE CLR. = CLEARANCE COL. = COLUMN CONC. = CONCRETE DN. = DOWN EL. = ELEVATION EPMD = ETHYLENE PROPYLENE DIENE MONOMER EXT. = EXTERIOR FDTN. = FOUNDATION GA. = GAUGE GALV. = GALVANIZED INT. = INTERIOR LF. = LINEAR FEET LVL. = LAMINATED VENEER LUMBER MAX. = MAXIMUM MIN. = MIN. = MINIMUM NTS. = NOT TO SCALE OPP. = OPPOSITE R.O. = ROUGH OPENING S.F. = SQUARE FEET T.O. = TOP OF TYP. = TYPICAL W/ = WITH " = INCHES ' = FEET

SYMBOLS: _______ ASSEMBLY DESIGNATION WALL TYPE TAG _______ NOTE DESIGNATION KEYNOTE TAG SHEET DETAIL

SHEET
DETAIL
BUILDING SECTION TAG

ELEVATION TAG

= NUMBER

SHEET DETAIL WALL SECTION TAG

RESTROOM ROOM NAME
SQUARE FOOTAGE
ROOM DESIGNATION TAG

WINDOW TYPE TAG

DESIGNATOR

DOOR TYPE TAG

DETAIL

A2.02

DETAIL

SHEET

DETAIL REFERENCE TAG

DESIGNATOR

SPOT ELEVATION TAG

SLOPE DIRECTION DESIGNATOR
SLOPE TAG

© — DESIGNATOR
BEAM SC.2
CENTERLINE TAG

ENTRANCE — MAIN ENTRANCE

ENTRANCE — SECONDARY ENTRANCE

COVERED SECONDARY ENTRANCE

CONTACT:


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TAYLOR LATIMER TIL@ANDREW.CMU.EDU
KYLE BANCROFT KYLEBANC@ANDREW.CMU.EDU



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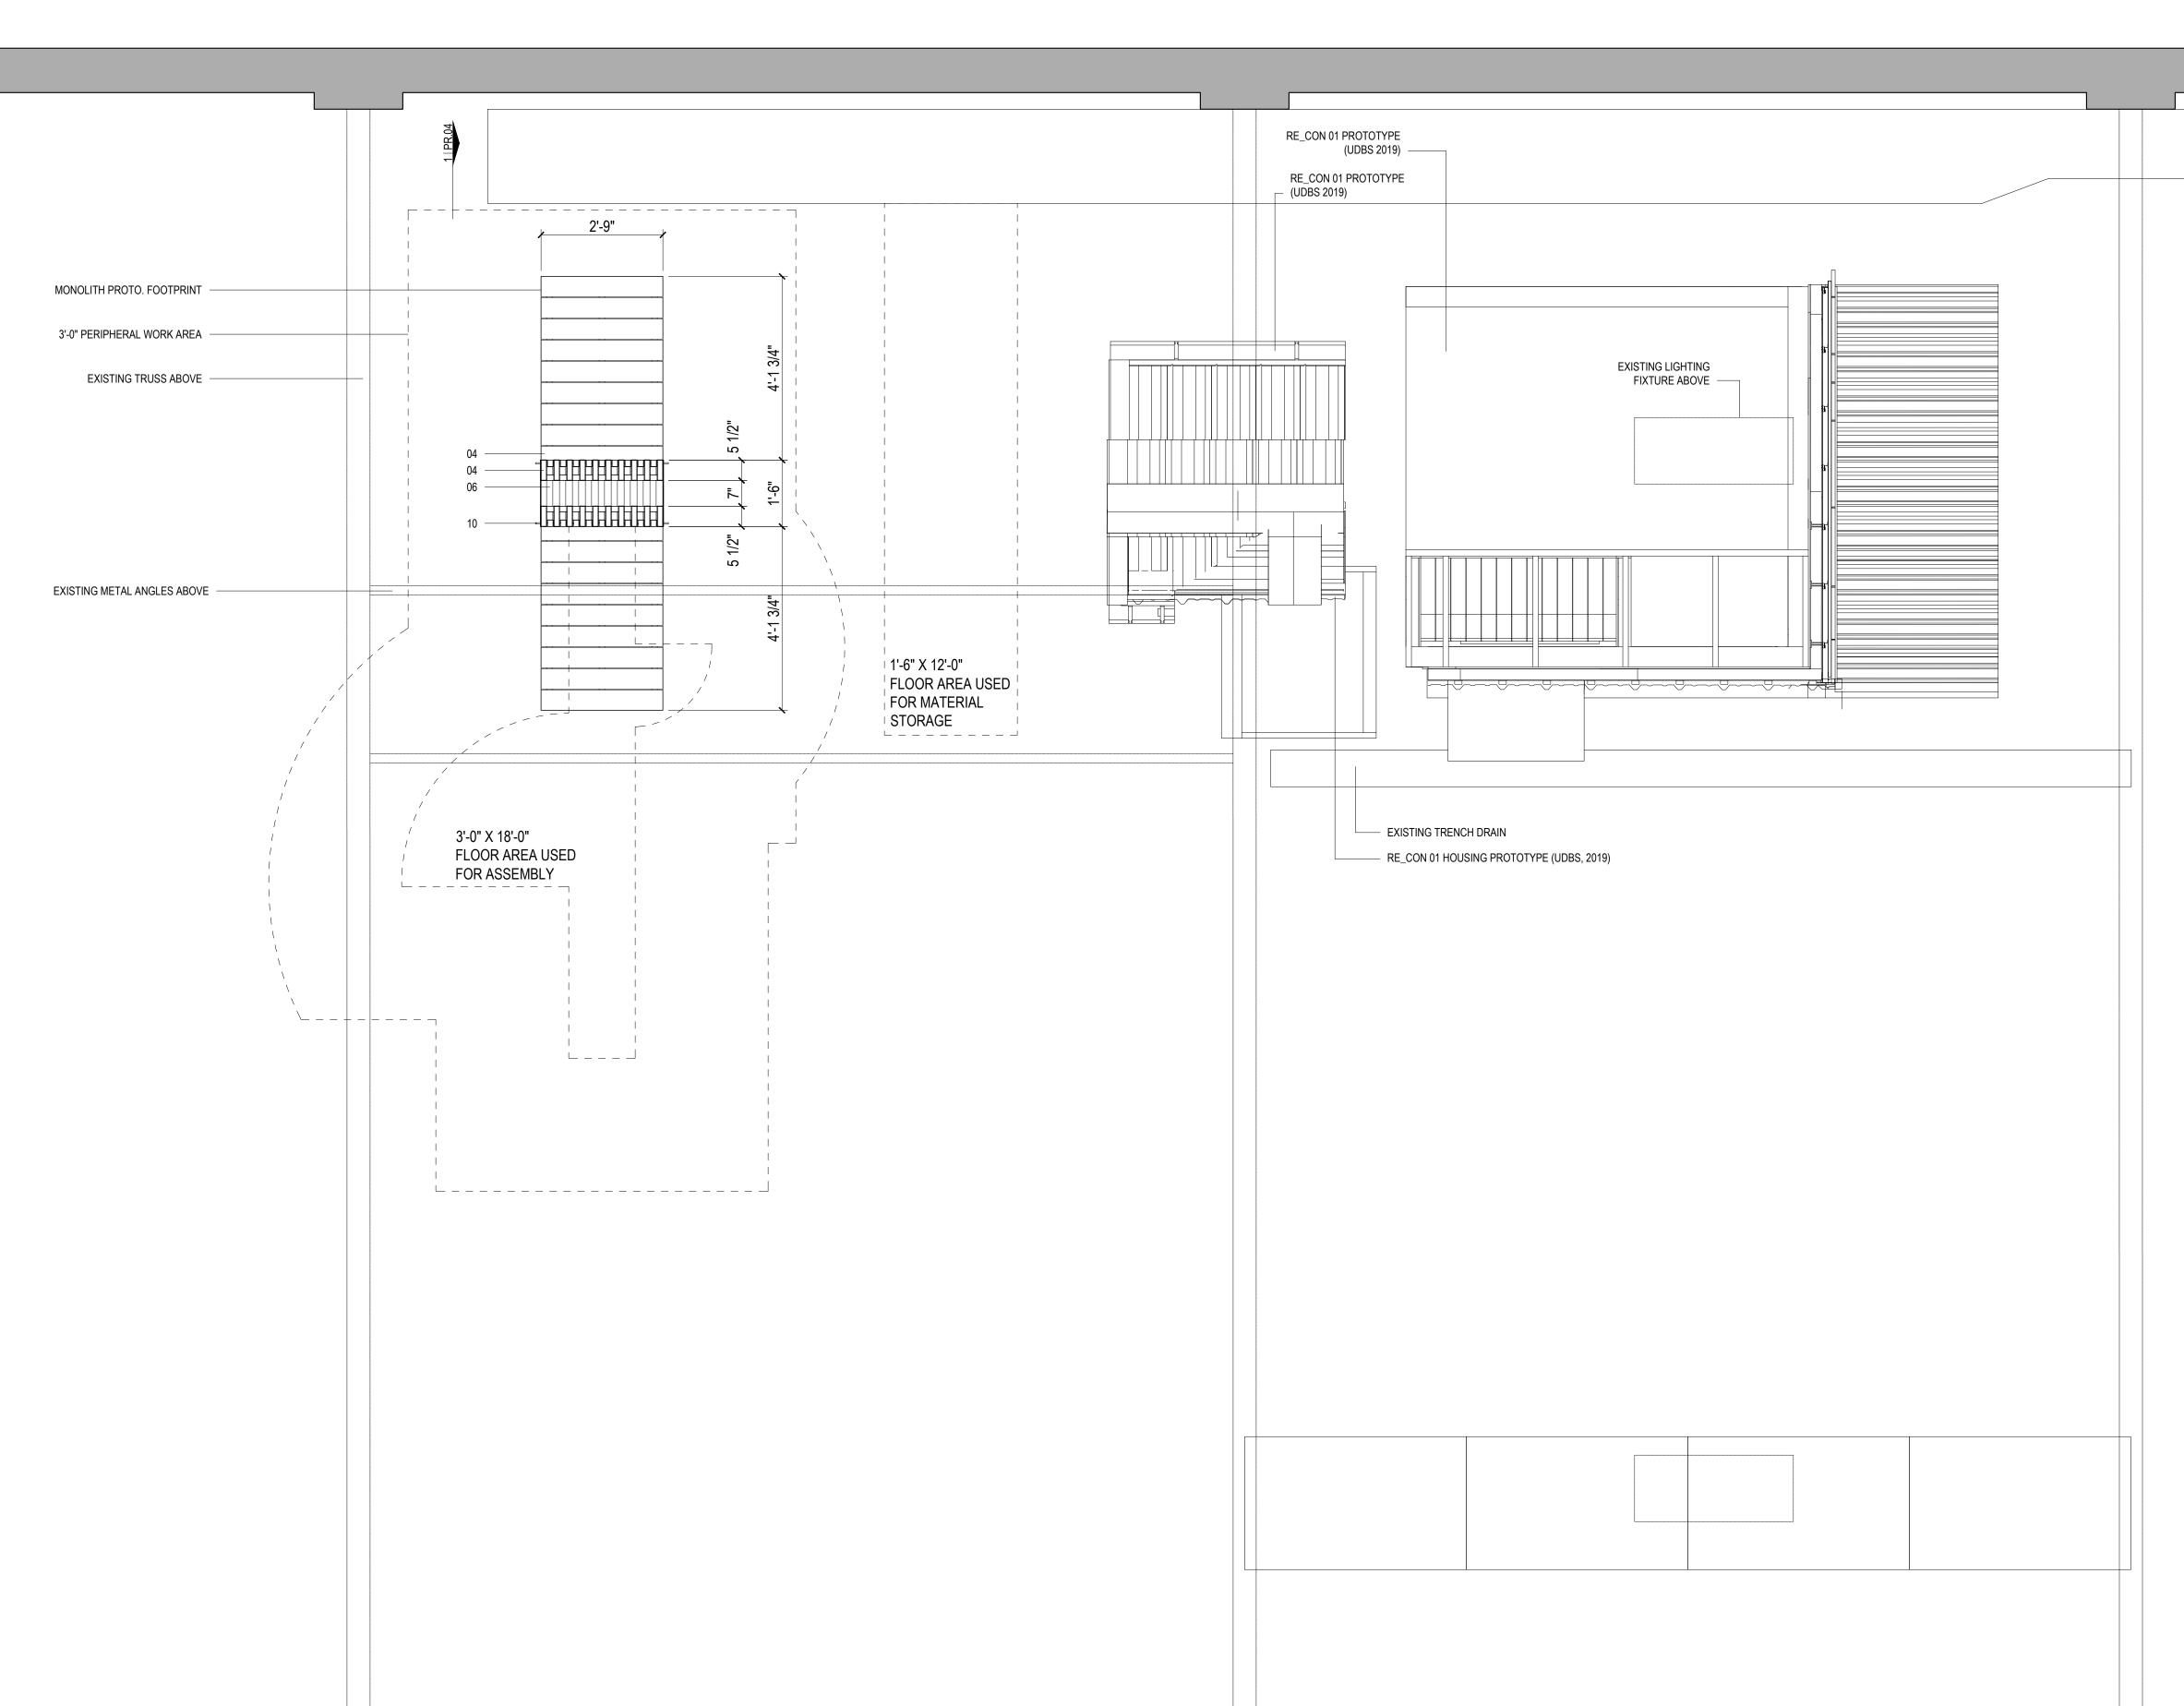
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DRAWN BY: KYLE BANCROFT TAKUMI DAVIS TAYLOR LATIMER

DECEMBER 2 0 1 9 F O R R E V I E W

PR.02

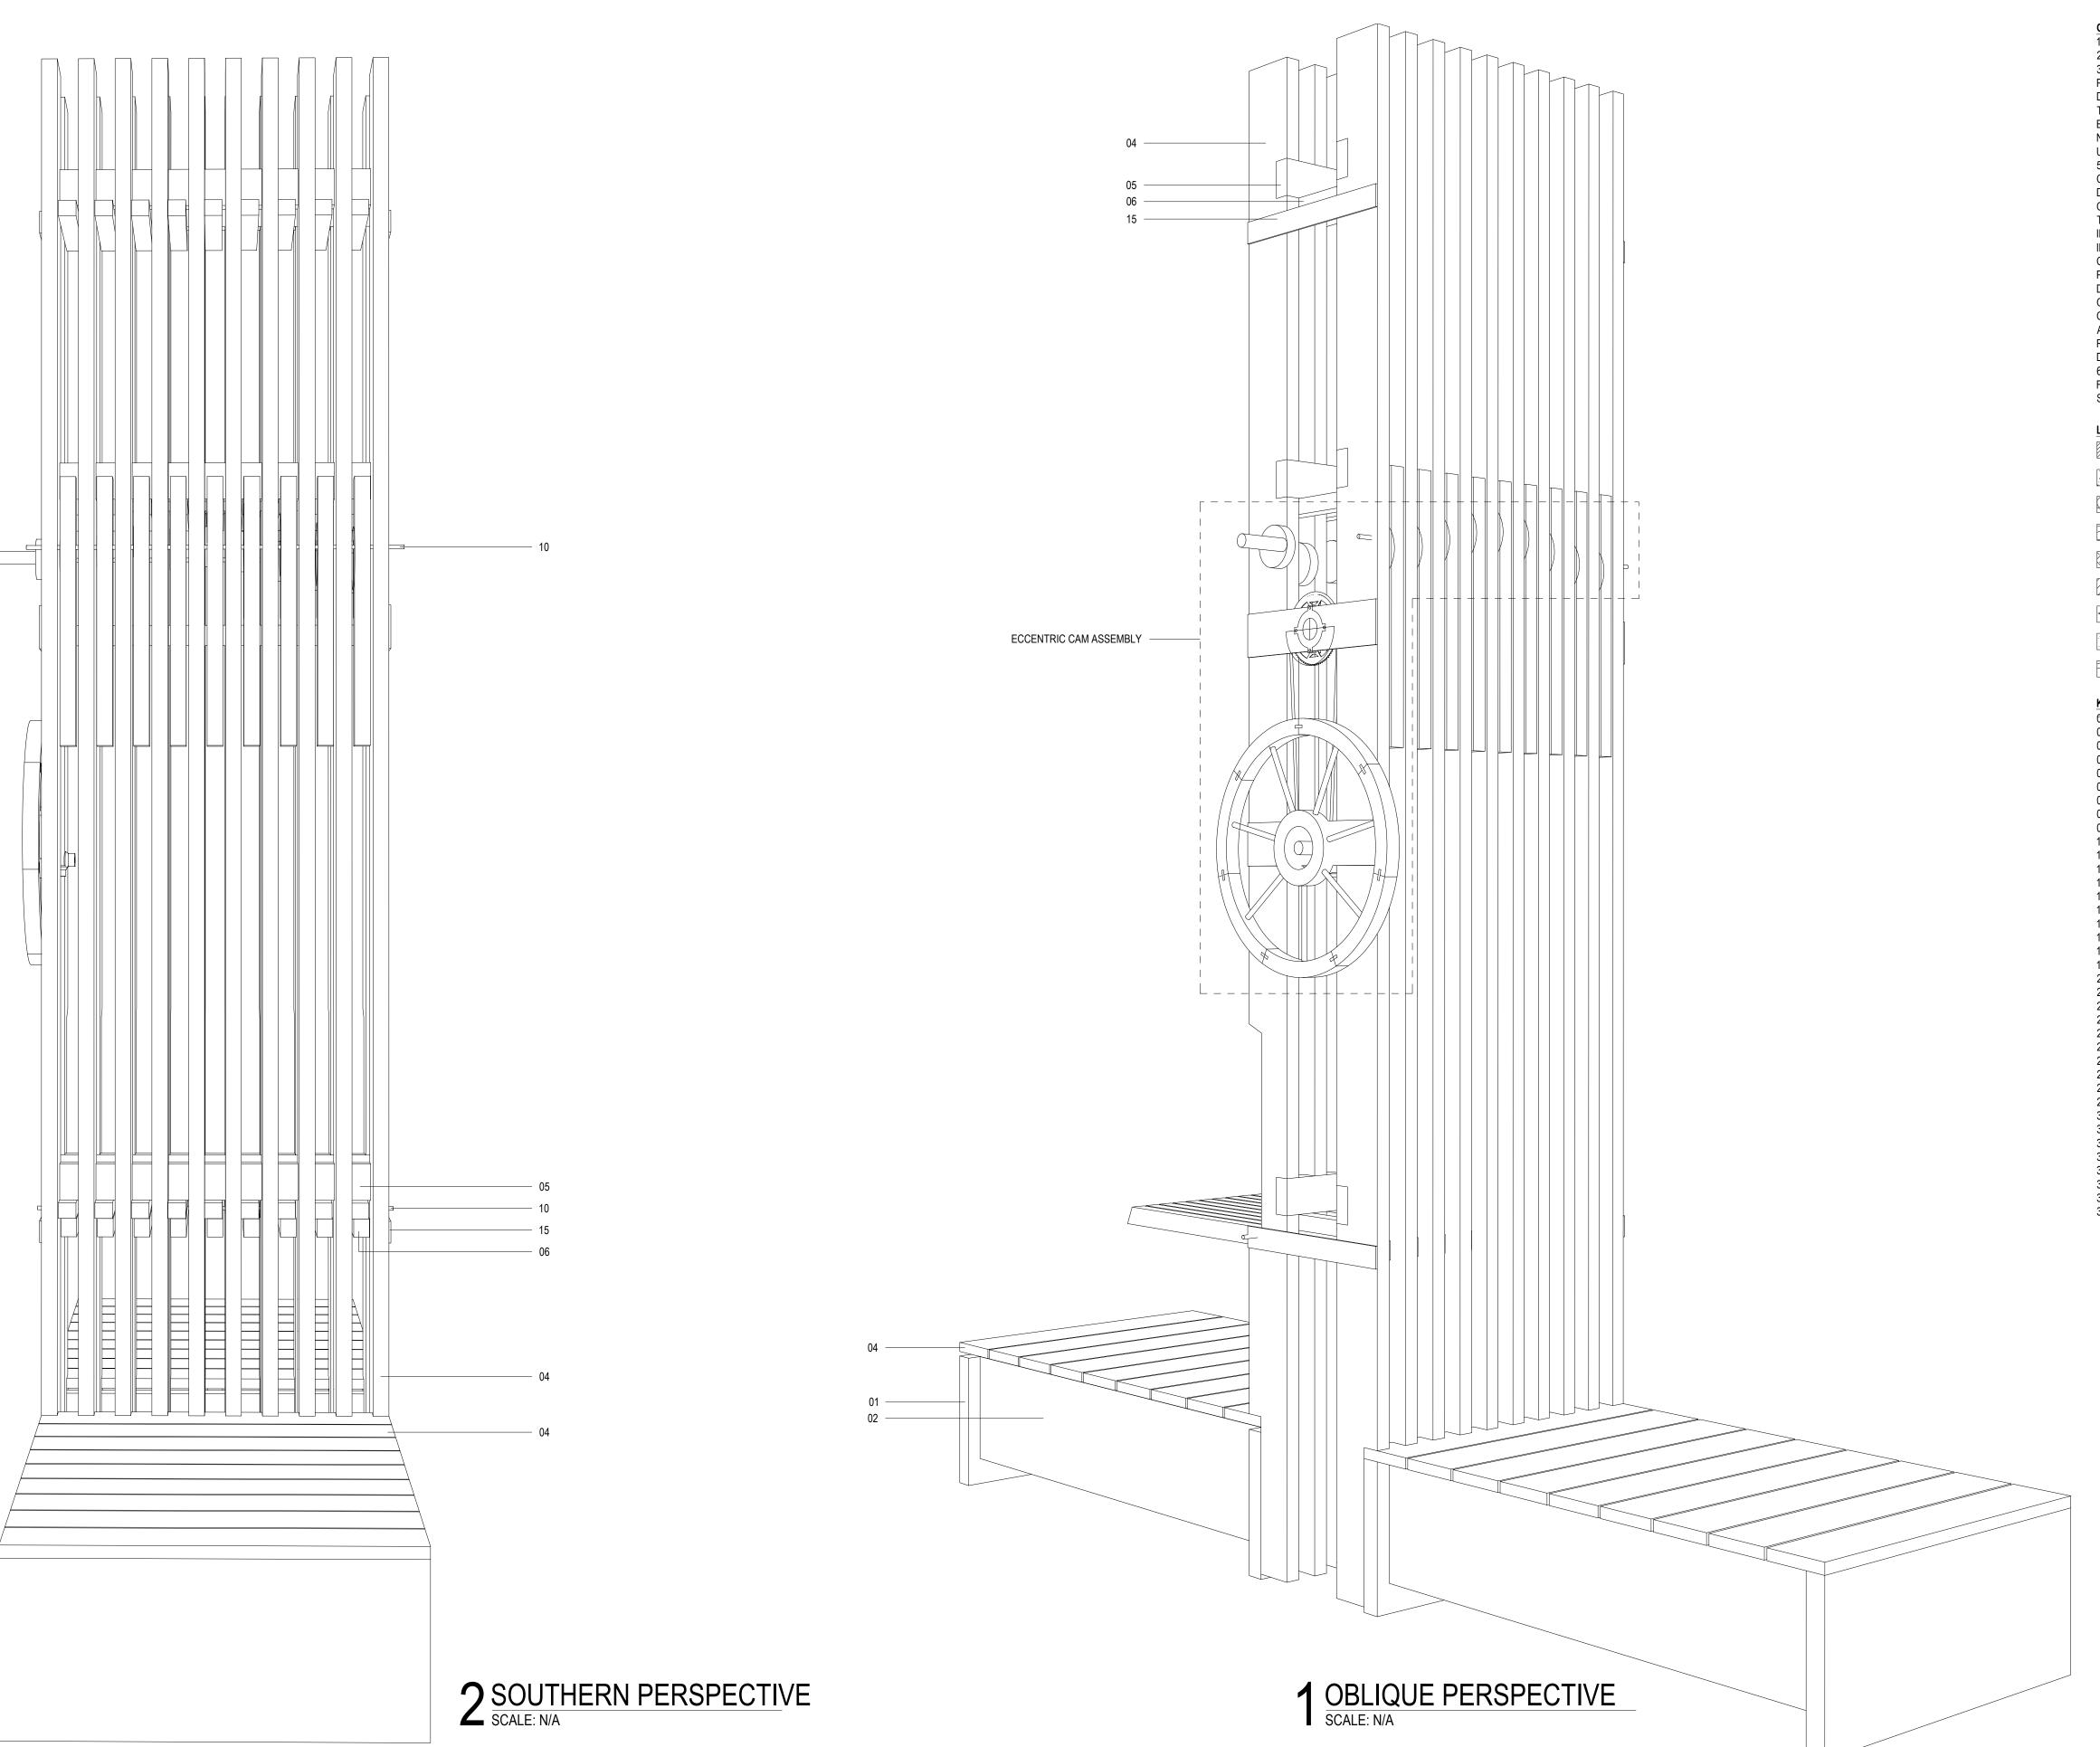

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CONC. PAVING

CLEAN CRUSHED STONE

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INFILL SOIL

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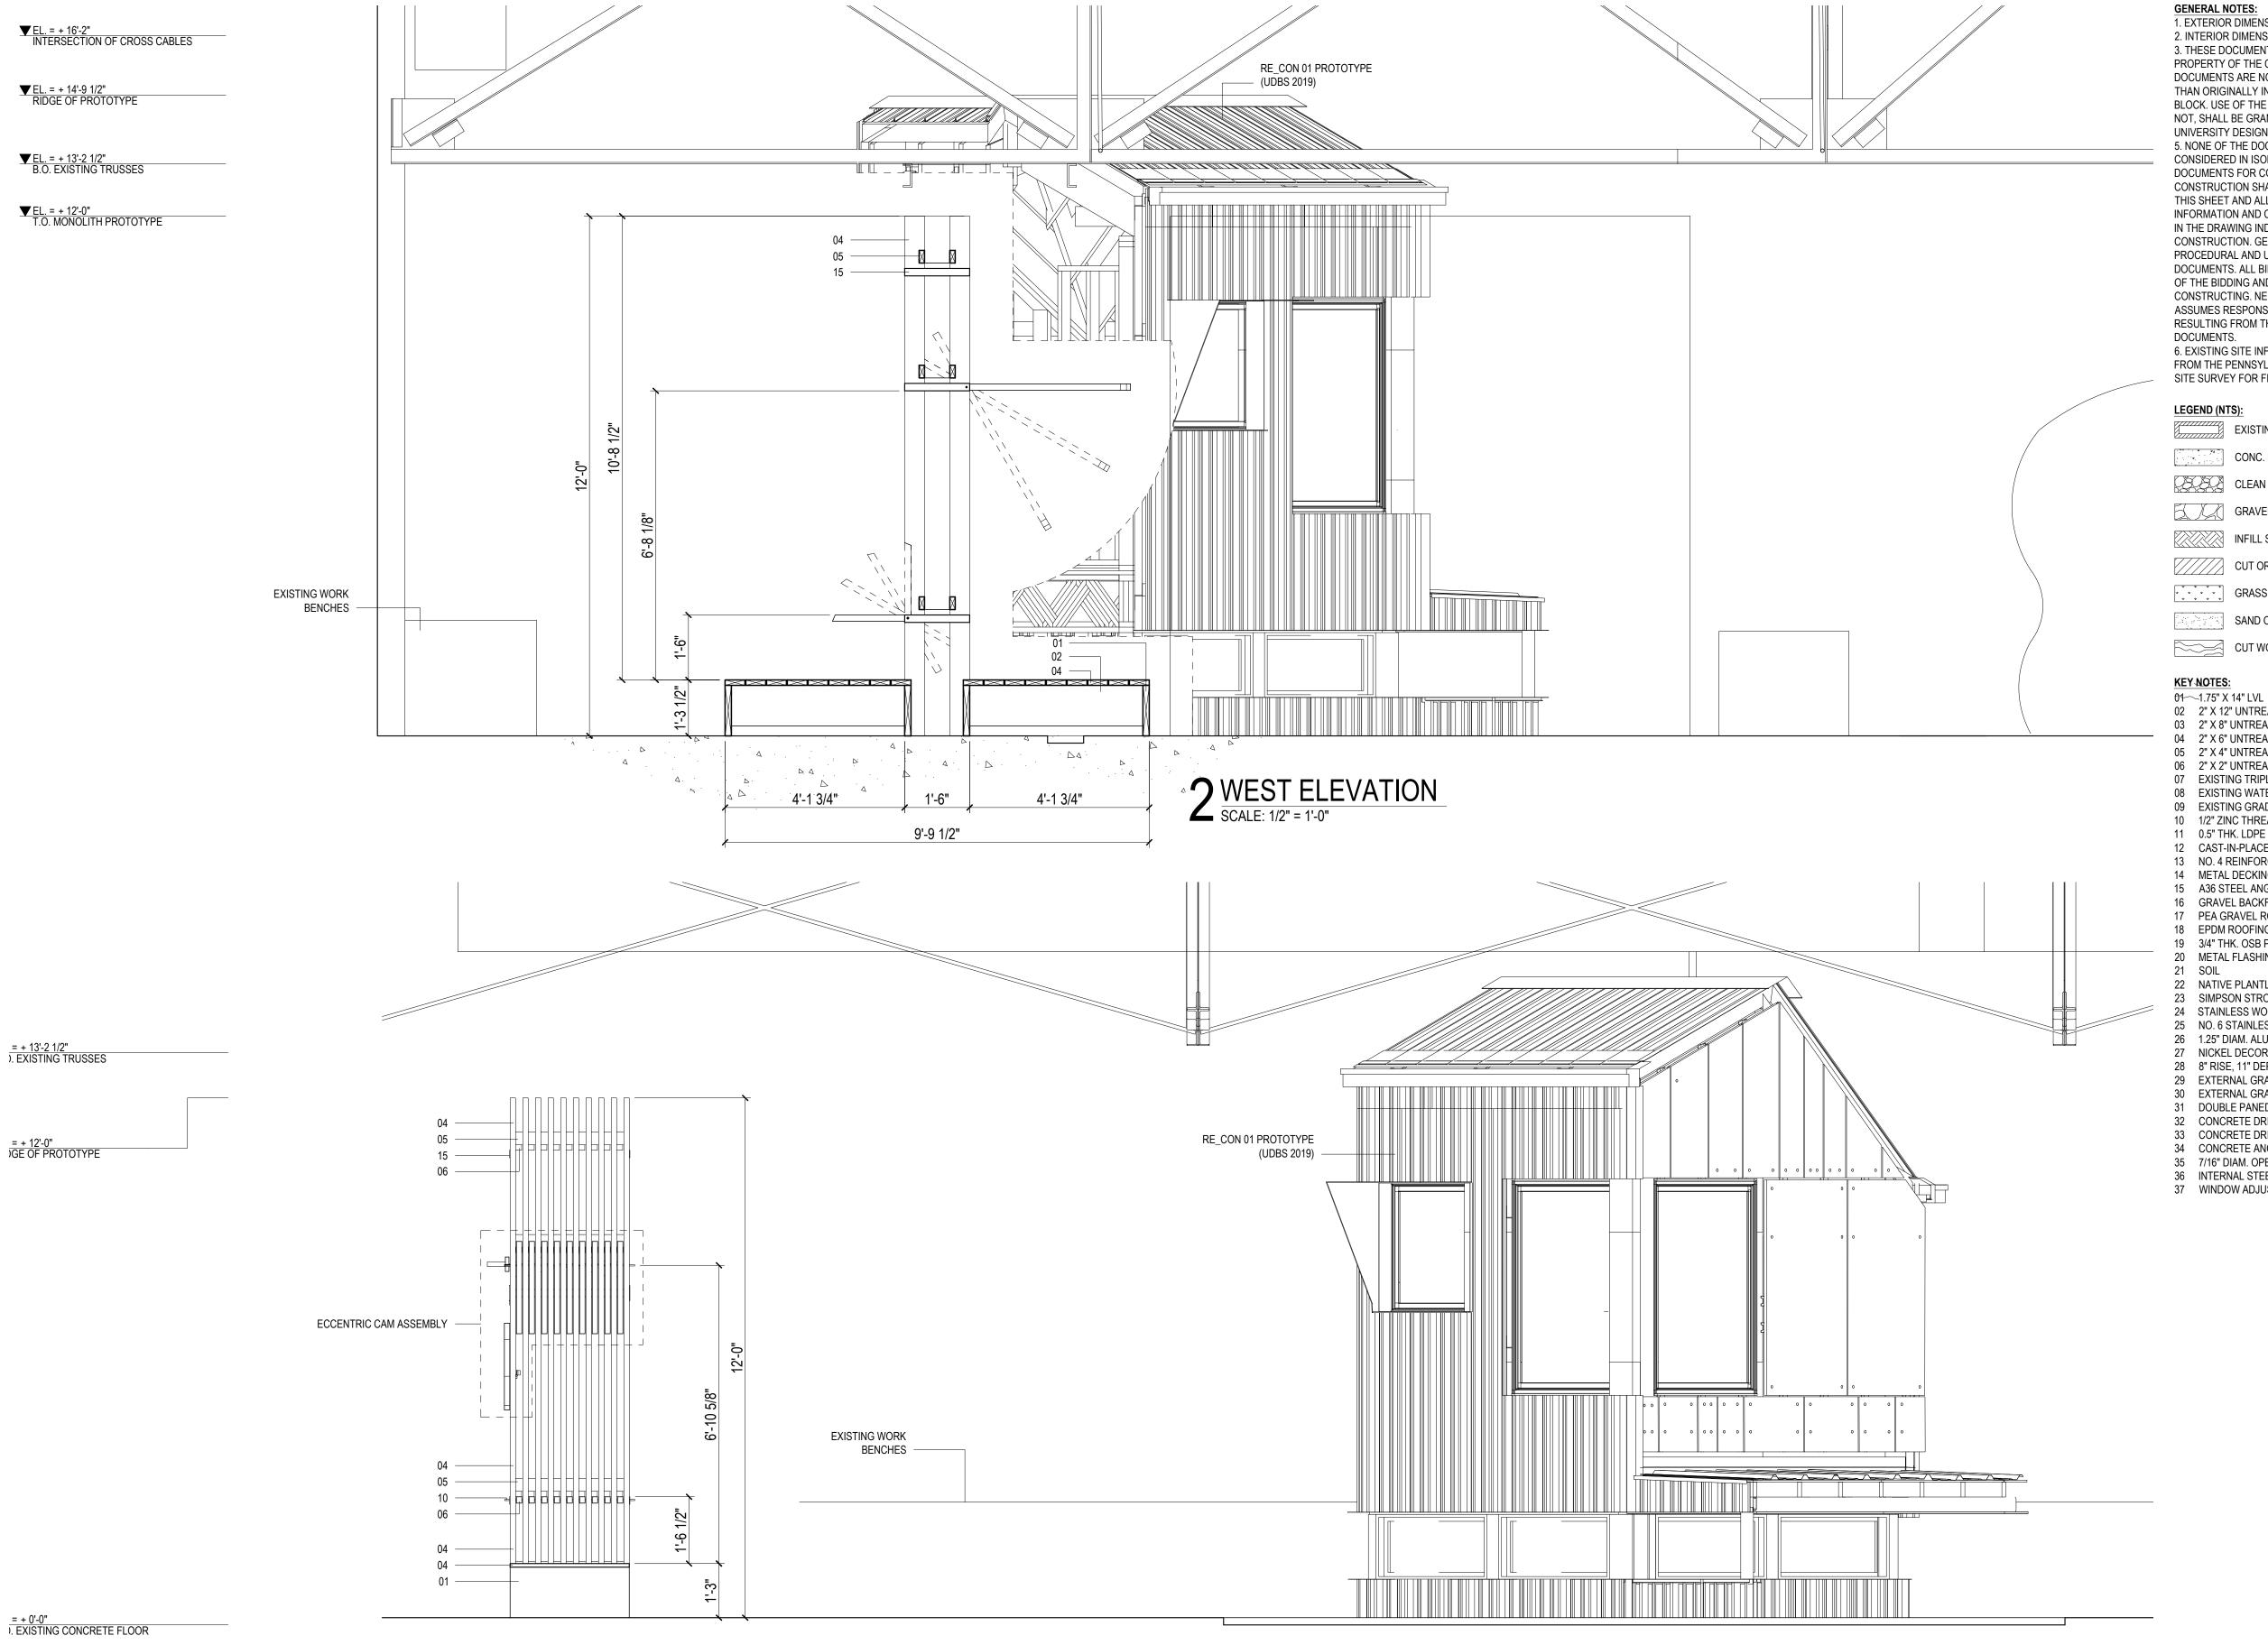
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DRAWN BY: KYLE BANCROFT TAKUMI DAVIS TAYLOR LATIMER

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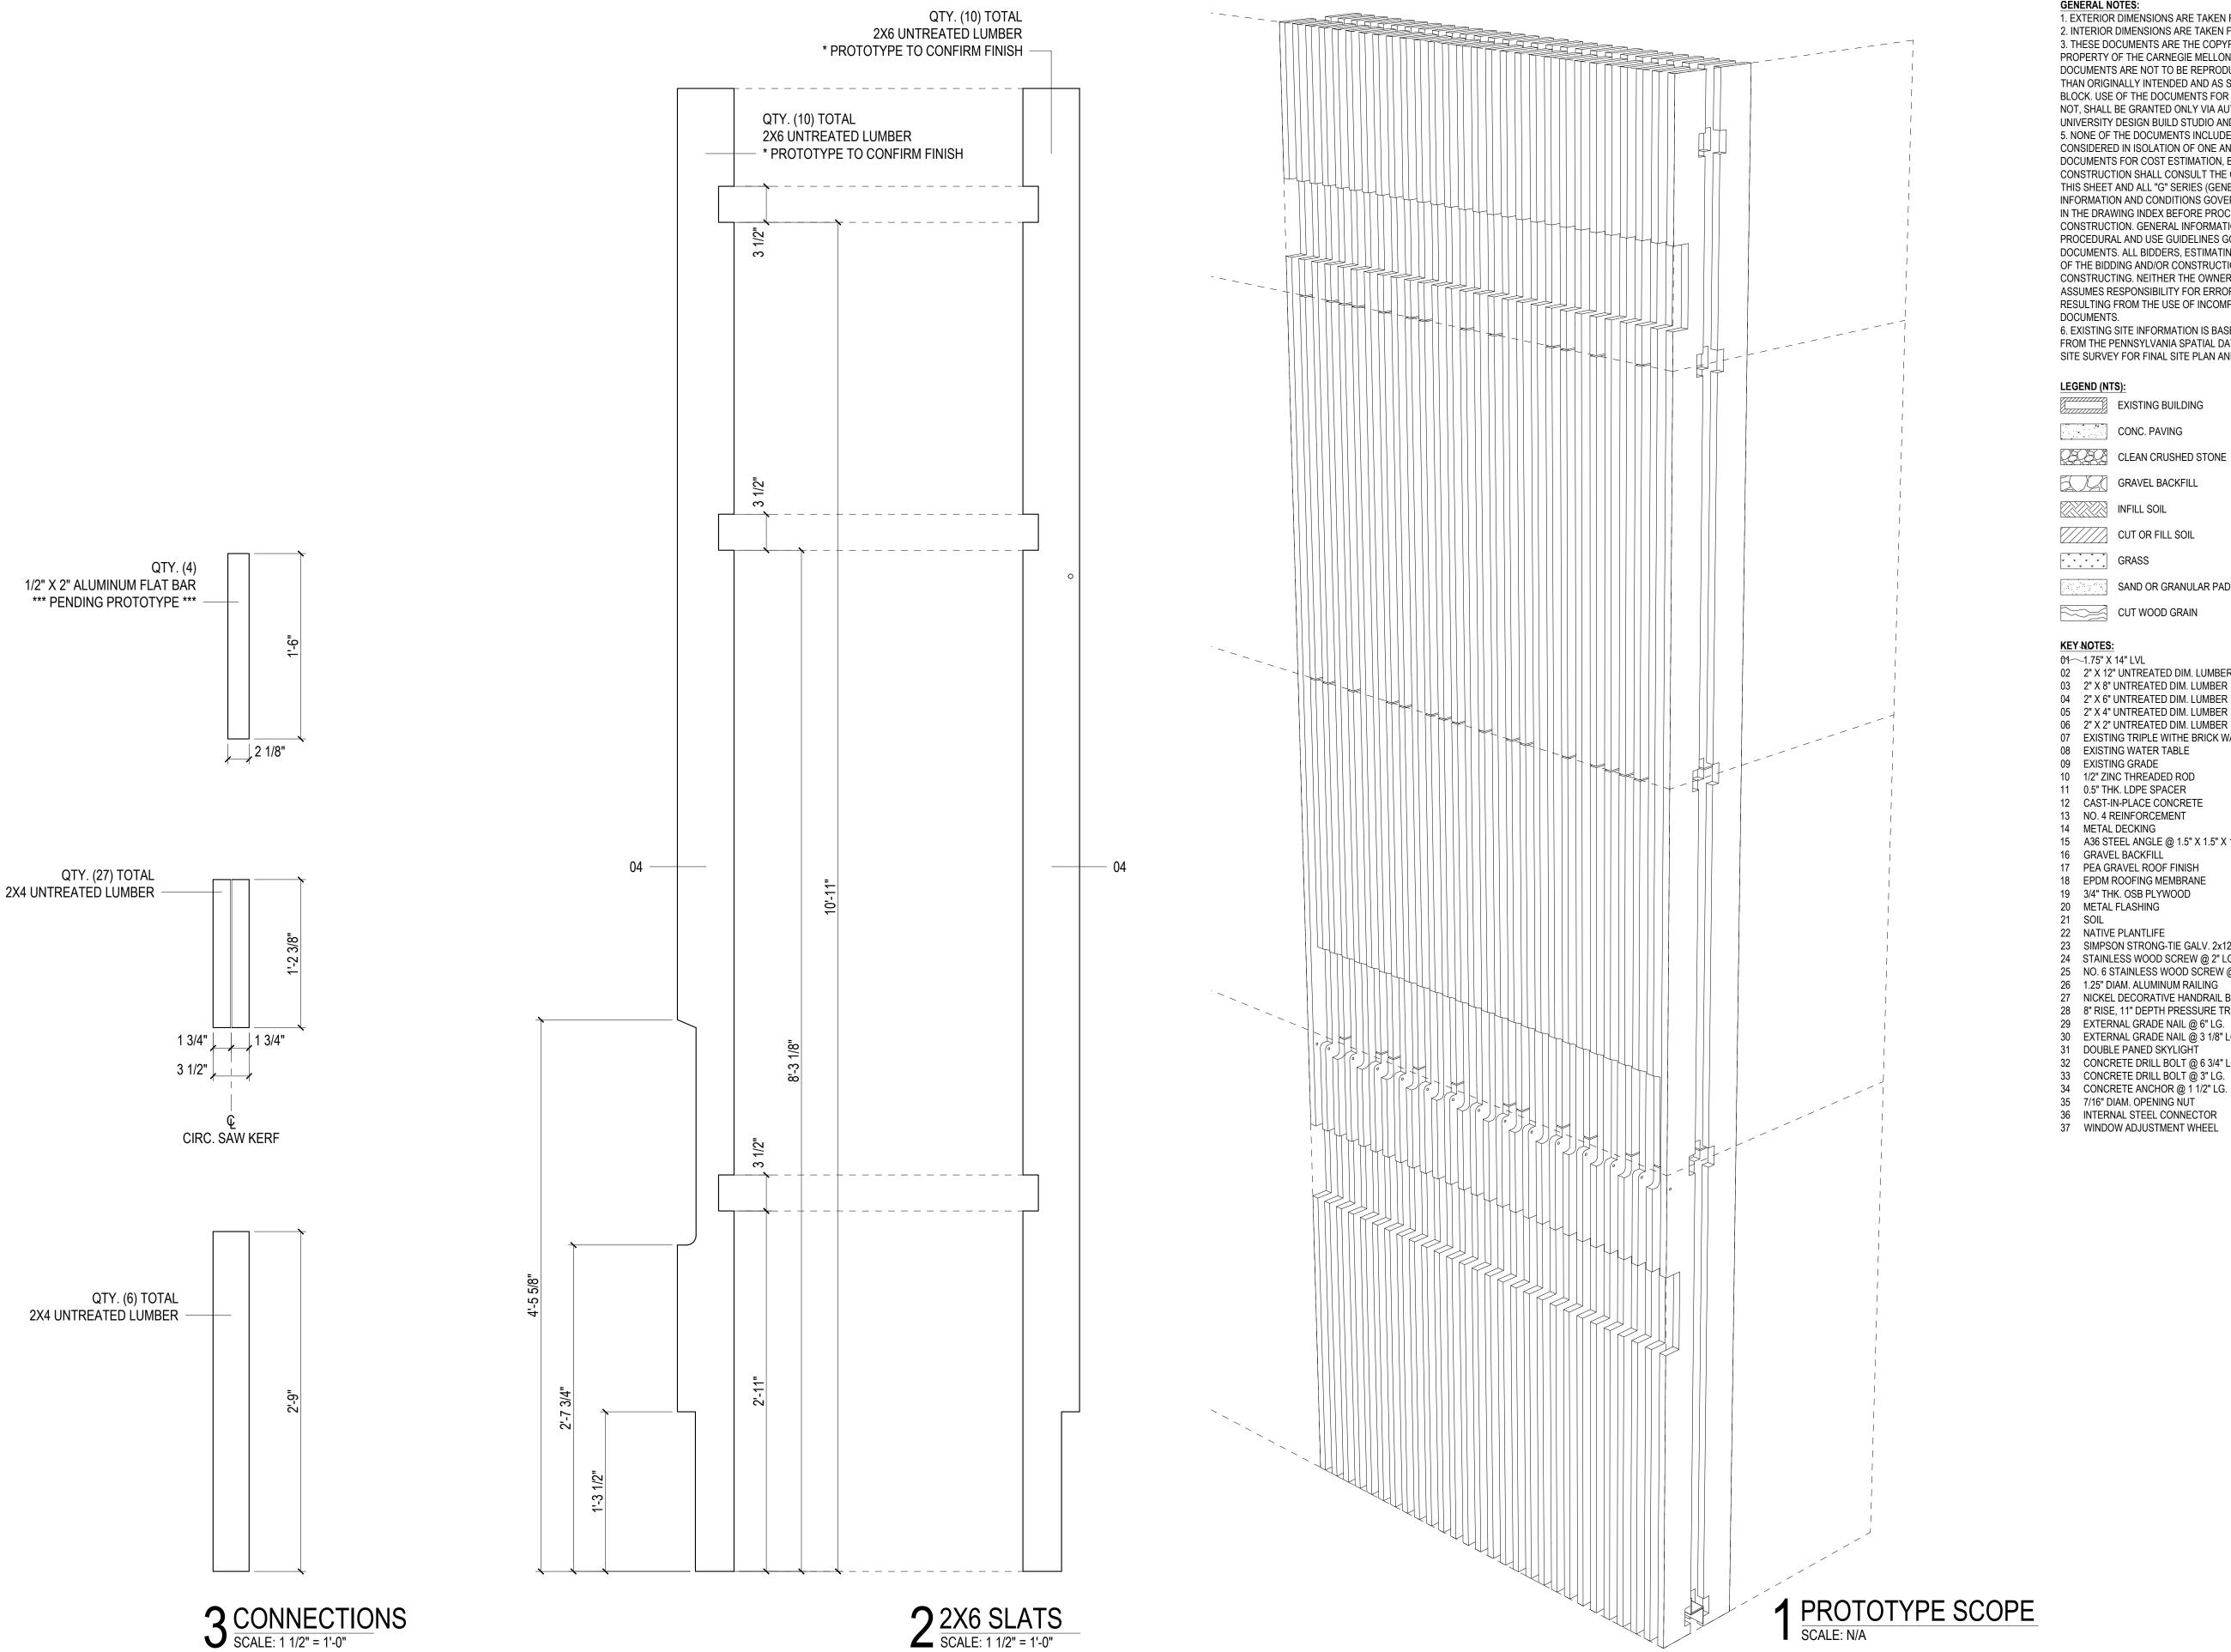
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F O R REVIEW

PR.04

SCALE: 1/2" = 1'-0"



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LEGEND (NTS):

EXISTING BUILDING

CONC. PAVING

CLEAN CRUSHED STONE GRAVEL BACKFILL

INFILL SOIL

CUT OR FILL SOIL

SAND OR GRANULAR PAD

CUT WOOD GRAIN

KEY NOTES:

- 02 2" X 12" UNTREATED DIM. LUMBER
- 03 2" X 8" UNTREATED DIM. LUMBER
- 05 2" X 4" UNTREATED DIM. LUMBER
- 06 2" X 2" UNTREATED DIM. LUMBER
- 07 EXISTING TRIPLE WITHE BRICK WALL 08 EXISTING WATER TABLE
- 09 EXISTING GRADE
- 10 1/2" ZINC THREADED ROD
- 11 0.5" THK. LDPE SPACER
- 12 CAST-IN-PLACE CONCRETE 13 NO. 4 REINFORCEMENT
- 14 METAL DECKING
- 15 A36 STEEL ANGLE @ 1.5" X 1.5" X 12 GA. 16 GRAVEL BACKFILL
- 17 PEA GRAVEL ROOF FINISH 18 EPDM ROOFING MEMBRANE
- 19 3/4" THK. OSB PLYWOOD 20 METAL FLASHING
- 22 NATIVE PLANTLIFE
- 23 SIMPSON STRONG-TIE GALV. 2x12 HANGER
- 24 STAINLESS WOOD SCREW @ 2" LG. 25 NO. 6 STAINLESS WOOD SCREW @ 1.25" LG. 26 1.25" DIAM. ALUMINUM RAILING
- 27 NICKEL DECORATIVE HANDRAIL BRACKET
- 28 8" RISE, 11" DEPTH PRESSURE TREATED STAIR STRINGER 29 EXTERNAL GRADE NAIL @ 6" LG.
- 30 EXTERNAL GRADE NAIL @ 3 1/8" LG. 31 DOUBLE PANED SKYLIGHT
- 32 CONCRETE DRILL BOLT @ 6 3/4" LG.
- 33 CONCRETE DRILL BOLT @ 3" LG. 34 CONCRETE ANCHOR @ 1 1/2" LG.
- 35 7/16" DIAM. OPENING NUT
- 36 INTERNAL STEEL CONNECTOR 37 WINDOW ADJUSTMENT WHEEL

DRAWN BY: KYLE BANCROFT TAKUMI DAVIS TAYLOR LATIMER

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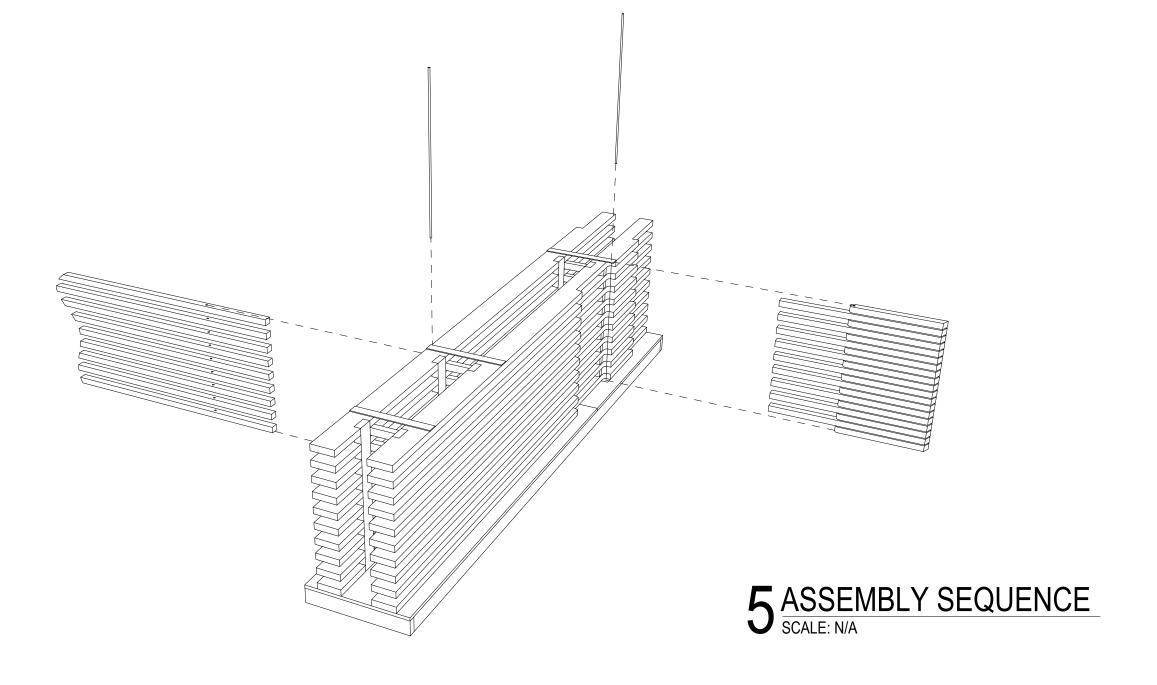
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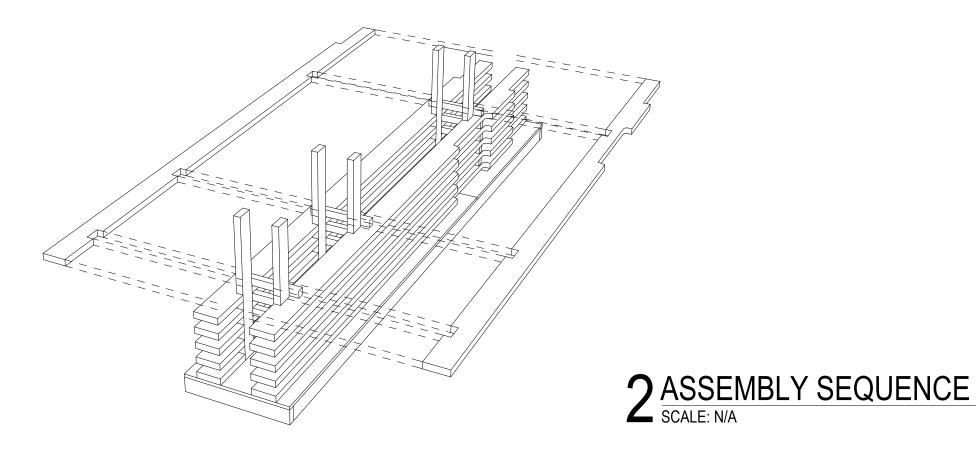
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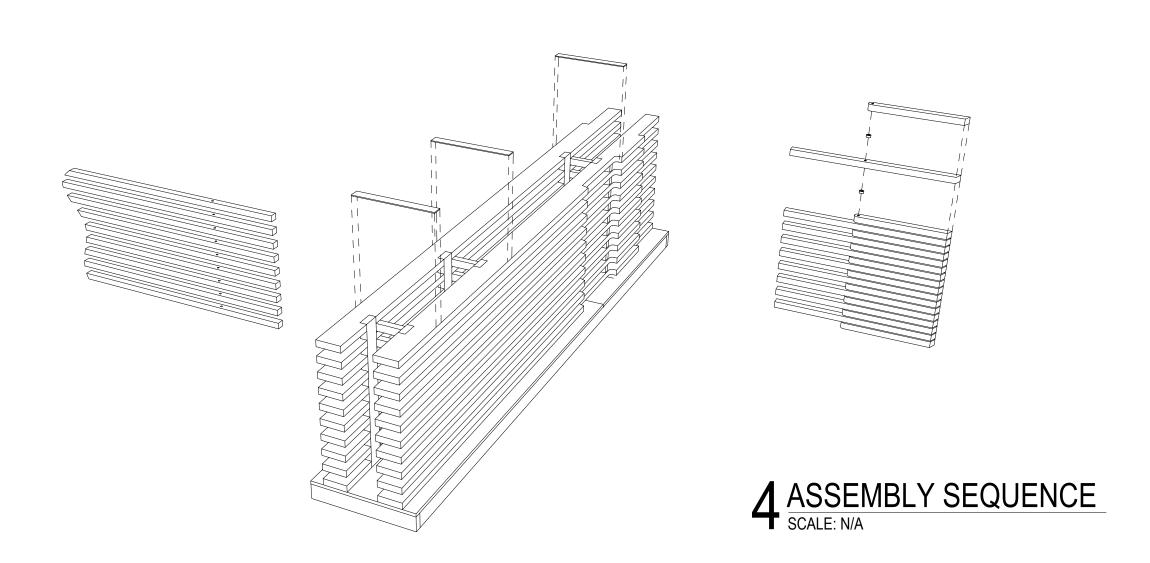
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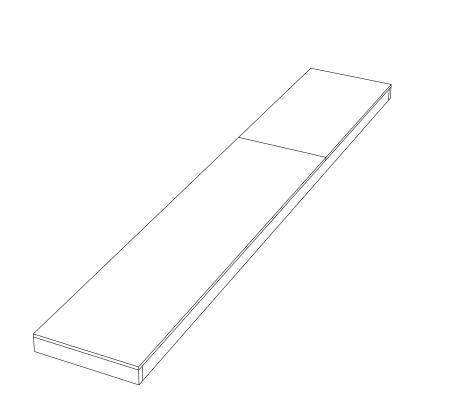
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3 ASSEMBLY SEQUENCE SCALE: N/A









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1 ASSEMBLY SEQUENCE SCALE: N/A